












GENERAL NOTES

1. THIS DRAWING IS INTENDED TO BE PRINTED IN COLOUR.
2. BACKGROUND SATELLITE IMAGERY IS INDICATIVE ONLY.
3. WATERCOURSE, WATERBODY DETAIL SHOWN IS OBTAINED FROM NSW SIX MAPS, CRS MGA ZONE 56.
4. SOLAR FARM DETAIL SHOWN IS PRELIMINARY, MAY CHANGE IN DETAILED DESIGN.

LEGEND

- | | |
|---|--------------------------------|
|  | TREE |
|  | LOT BOUNDARY |
|  | MAJOR CONTOUR |
|  | MINOR CONTOUR |
|  | SECURITY FENCE |
|  | LEASE BOUNDARY |
|  | (PROPOSED)
FENCE (EXISTING) |
|  | ACCESS ROAD |
|  | O/H 11kV POWERLINE |
|  | O/H 132kV LINES |
|  | WATERCOURSE
(NOTE 4) |

REFERENCES	REV	DATE	DESCRIPTION	DRAWN.	DESIGNED	CHKD.	APPR.
REVISIONS	G	2020.12.07	REVISED LEASE BOUNDARY	JM	JM	SS	JM
	F	2020.12.07	MINOR REVISION	JM	JM	SS	JM
	E	2020.12.04	MINOR REVISION	JM	JM	SS	JM
	D	2020.12.03	MINOR REVISION	JM	JM	SS	JM
	C	2020.11.23	RE-ISSUED WITH CHANGES	JM	JM	SS	JM
	REV.	DATE	DESCRIPTION	DRAWN.	DESIGNED	CHKD.	APPR.

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GROUP OR AN AUTHORIZED AGENT.

TITLE	PROVIDENCE ASSET GROUP WARRAL SOLAR FARM GENERAL ARRANGEMENT OVERVIEW
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DWG No.	10040-G-GAD-02-1
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SCALE	1:5000
REVISION	G
PAPER SIZE	A3

A

B

C

D












A

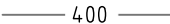B

C

D

LEGEND

-  TREE, REMOVED
-  TREE, RETAINED
-  400 MAJOR CONTOUR
-  MINOR CONTOUR
-  SECURITY FENCE
-  FENCE (EXISTING)
-  LEASE BOUNDARY (PROPOSED)
-  PV TABLE
-  O/H 11kV POWERLINE
-  O/H 132kV LINES
-  WATERCOURSE

SYSTEM SUMMARY

ELECTRICAL CONFIGURATION:
TOTAL PV PLANT CAPACITY (DC): 6.441 MWp
TOTAL INVERTER CAPACITY (AC): 4.95MVA
PV PLANT MAXIMUM EXPORT CAPACITY (AC): 4.95MW
DC:AC RATIO: 1.301
STRINGS OF 28 PV MODULES.
213 PV STRINGS PER INVERTER.
426 PV STRINGS TOTAL.

PV MODULES:
MFR: LONGI SOLAR
MODEL: LR5-72HPH-540M
NAMEPLATE: 540Wp
QUANTITY: 11,928 MODULES

INVERTERS:
MFR: SUNGROW
MODEL: SG2475HV
NAMEPLATE: 2475kVA
QUANTITY: 2


MV POWER STATION:
MFR: SUNGROW
MODEL: SG4950HV-MV
QUANTITY: 1

TRACKER ARRAY:
TYPE: GROUND MOUNT SINGLE AXIS TRACKING
CONFIGURATION: INDEPENDENT TYPE
MFR: NEXTRACKER
RANGE OF MOTION: ±60°
PITCH: 6.3m
GCR: 35.81%
QUANTITY: 142 TABLES

FENCED AREA: 116,578 m²
LEASE AREA: 133,666 m²

GENERAL NOTES:

1. DETAIL SHOWN IS PRELIMINARY, MAY CHANGE IN DETAILED DESIGN.
2. SITE ACCESS VIA COUNTRY ROAD.
3. CLEARANCE BETWEEN SOLAR TRACKER ARRAY & SITE SECURITY FENCE TYPICALLY 10m, MAY VARY.
4. HV RMU & METERING (LOCATION AND TYPE TO BE DETERMINED, IS SUBJECT TO ESSENTIAL ENERGY FEEDBACK)
5. FOR SECURITY GATE DETAILS REFER TO DRAWING 10020-C-DET-02-1.
6. WATERCOURSE DETAIL SHOWN IS OBTAINED FROM NSW SIX MAPS, CRS MGA ZONE 56.
7. ON SITE WATER DETENTION DETAIL SHOWN IS PRELIMINARY, REFER TO 10040-C-DET-01-1 FOR FURTHER DETAIL.

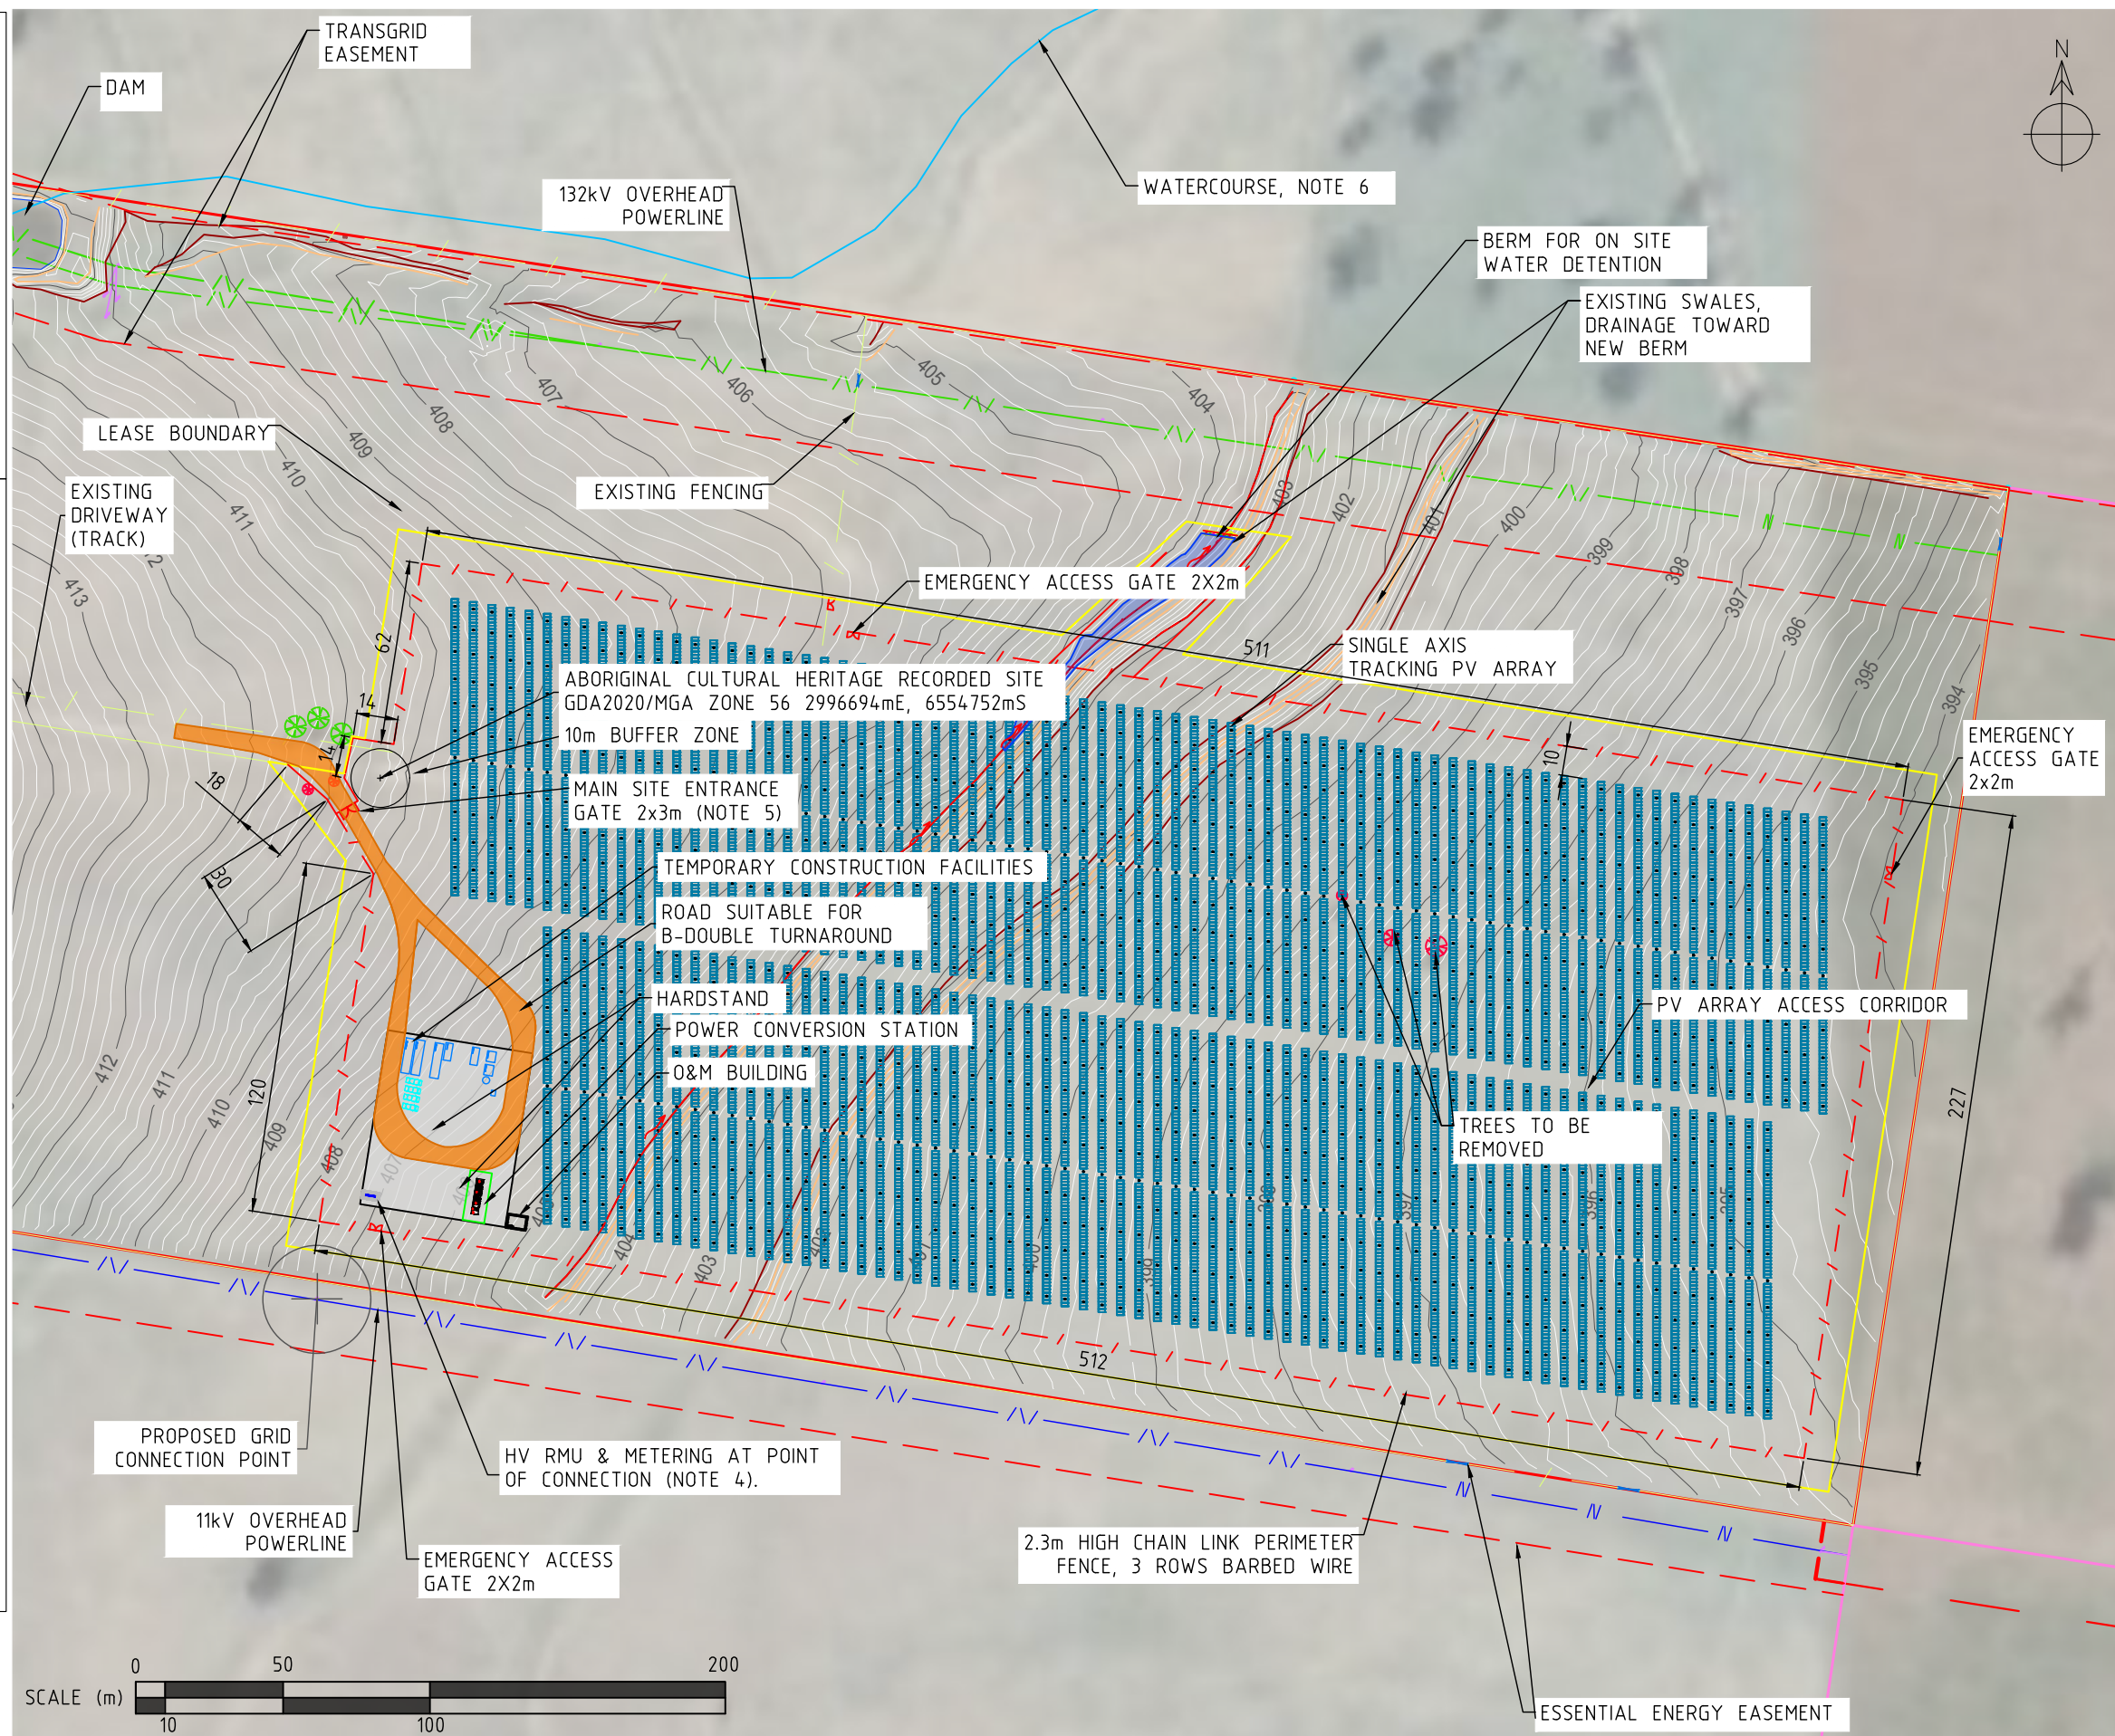

REV	DATE	DESCRIPTION	DRWN.	DESIGNED	CHKD.	APPR.
F	2020.12.09	REVISED LEASE BOUNDARY	JM	JM	SS	JM
E	2020.12.07	REVISED LEASE BOUNDARY	JM	JM	SS	JM
D	2020.12.04	REVISED LEASE BOUNDARY	JM	JM	SS	JM
C	2020.12.03	ISSUED WITH CHANGES	JM	JM	SS	JM
B	2020.11.23	ISSUED WITH CHANGES	JM	JM	SS	JM


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TITLE	PROVIDENCE ASSET GROUP WARRAL SOLAR FARM GENERAL ARRANGEMENT SYSTEM DETAIL
DWG No.	10040-G-GAD-02-2


SCALE	1:2350
REVISION	F
PAPER SIZE	A3

GENERAL NOTES

- 1. DETAILS SHOWN ARE PRELIMINARY, PAVEMENT DESIGN SUBJECT TO FINAL TRAFFICABILITY ASSESSMENT.
- 2. TRAFFIC LANE TYPICAL WIDTHS OF 4m TO 5m AS SHOWN. SECTIONS MAY BE WIDER THAN SHOWN TO ACCOMMODATE REQUIRED VEHICLE TURNING CIRCLES.
- 3. ALL ROADS TO HAVE ADEQUATE CROSS FALL FROM CENTER AND SHALL MAINTAIN MINIMUM LAYER THICKNESSES PER THE PAVEMENT DESIGNS.
- 4. ACCESS ROAD SHALL BE RAISED MINIMUM 150mm ABOVE EXISTING GROUND LEVEL.

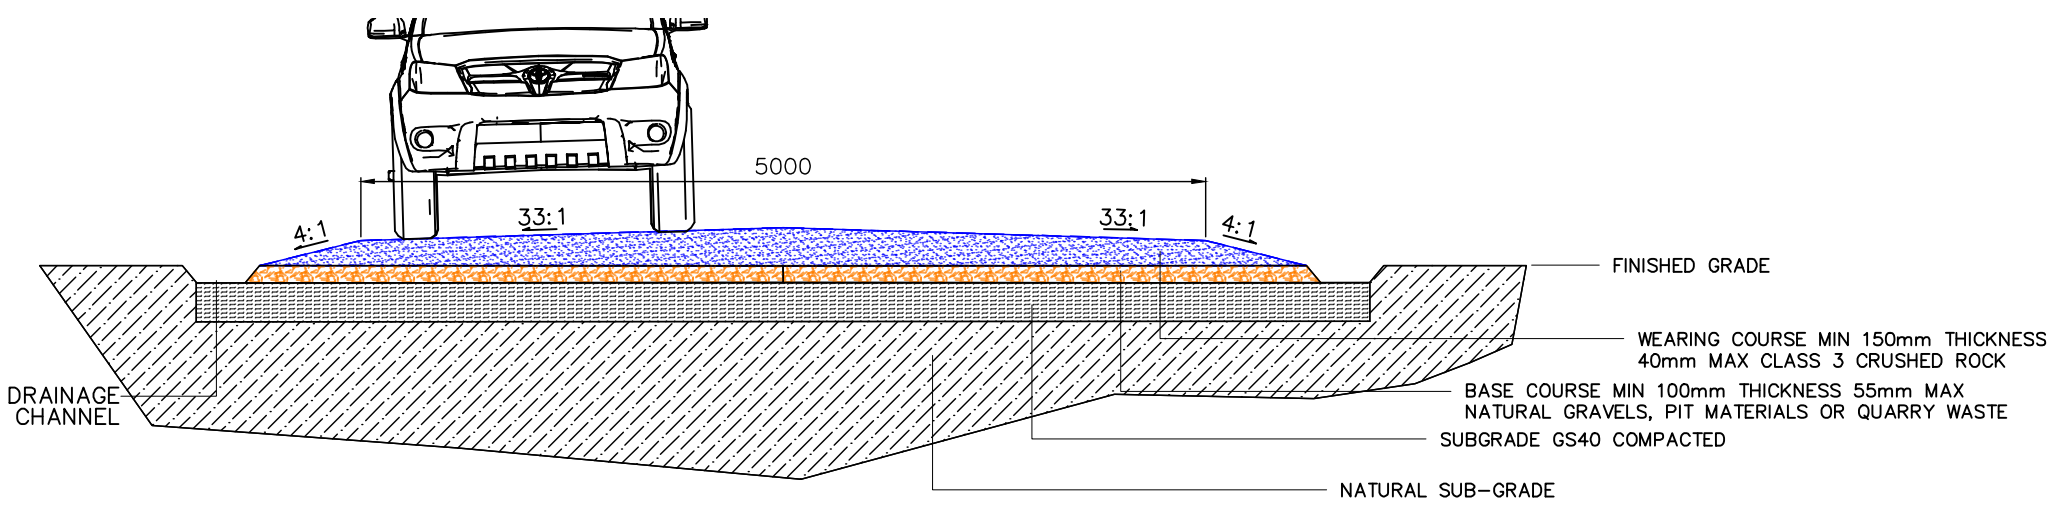

1 SITE ACCESS ROAD SECTION

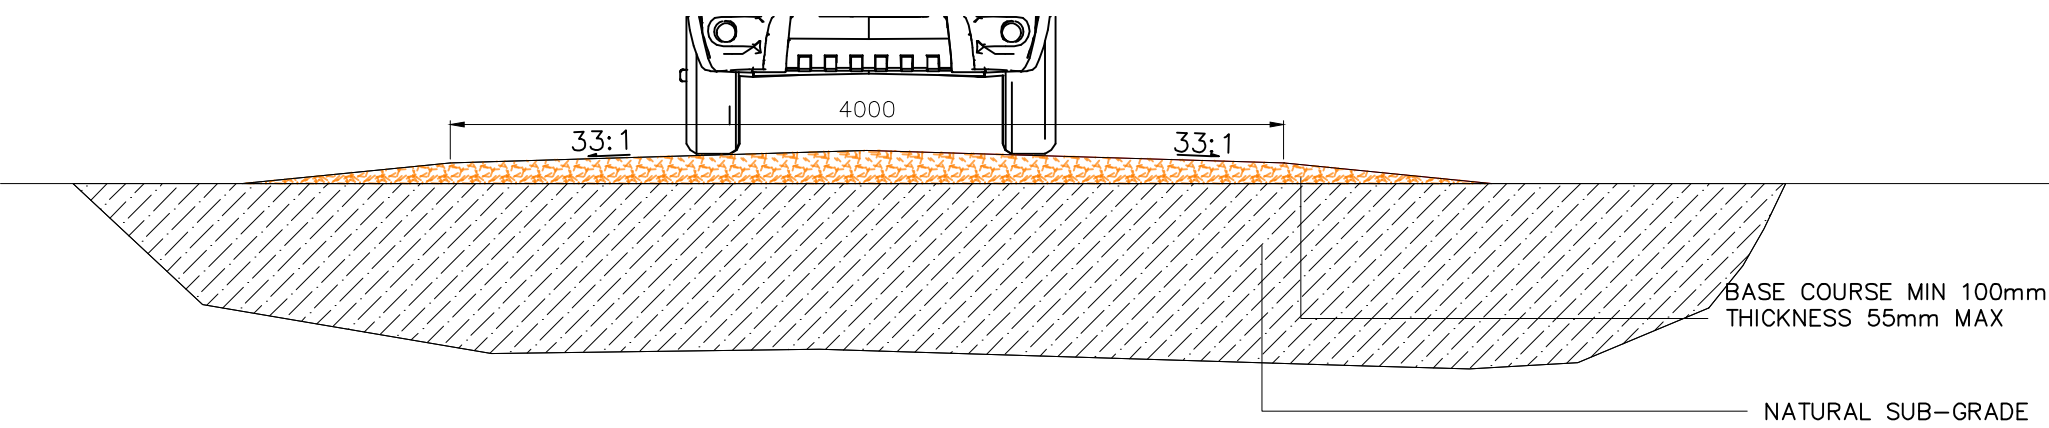

2 PV ARRAY ACCESS ROAD SECTION



REV.	DATE	DESCRIPTION	DRWN.	DESIGNED	CHKD.	APPR.
A	2020.12.08	FIRST ISSUE	JM	JM	SS	JM

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TITLE	PROVIDENCE ASSET GROUP WARRAL SOLAR FARM ROAD SECTION DETAIL TYPICAL	SCALE	AS SHOWN
DWG No.	10040-C-DET-06-1	REVISION	A
		PAPER SIZE	A3

GENERAL NOTES


- 1. NB DETAIL PRESENTED IS PARALLEL PROJECTION. PV TRACKERS WILL BE 1-MODULE-IN PORTRAIT SINGLE AXIS TRACKING TYPE, AND WILL BE POSITIONED SUFFICIENTLY FAR FROM THE FENCELINE AS TO APPEAR SMALLER THAN AS SHOWN.
- 2. PRELIMINARY EQUIPMENT SELECTION:
PV MODULE: LONGI LR5-72HPH-540M
TRACKING SYSTEM: NEXTRACKER NX HORIZON
DETAIL PRESENTED IS BASED UPON EQUIPMENT SELECTION, MAY CHANGE DURING DETAILED DESIGN.
- 3. GROUND LEVEL SIMPLIFIED TO CONSTANT ELEVATION, GROUND LEVEL VARIES ACROSS SITE.
- 4. REFER TO 10040-C-DET-02-1 FOR FENCING DETAIL.
- 5. LANDSCAPING EXTERNAL TO FENCE NOT SHOWN.

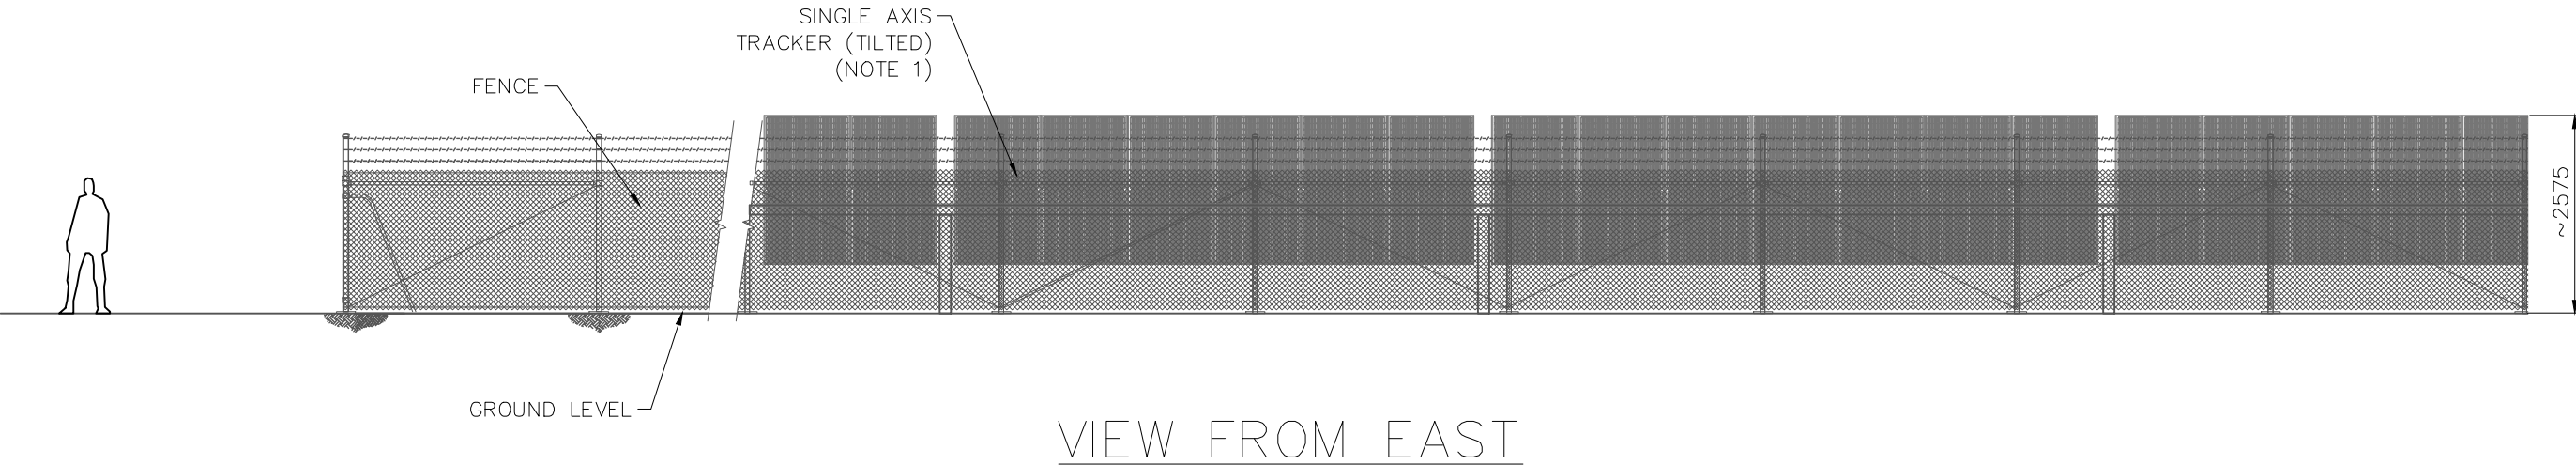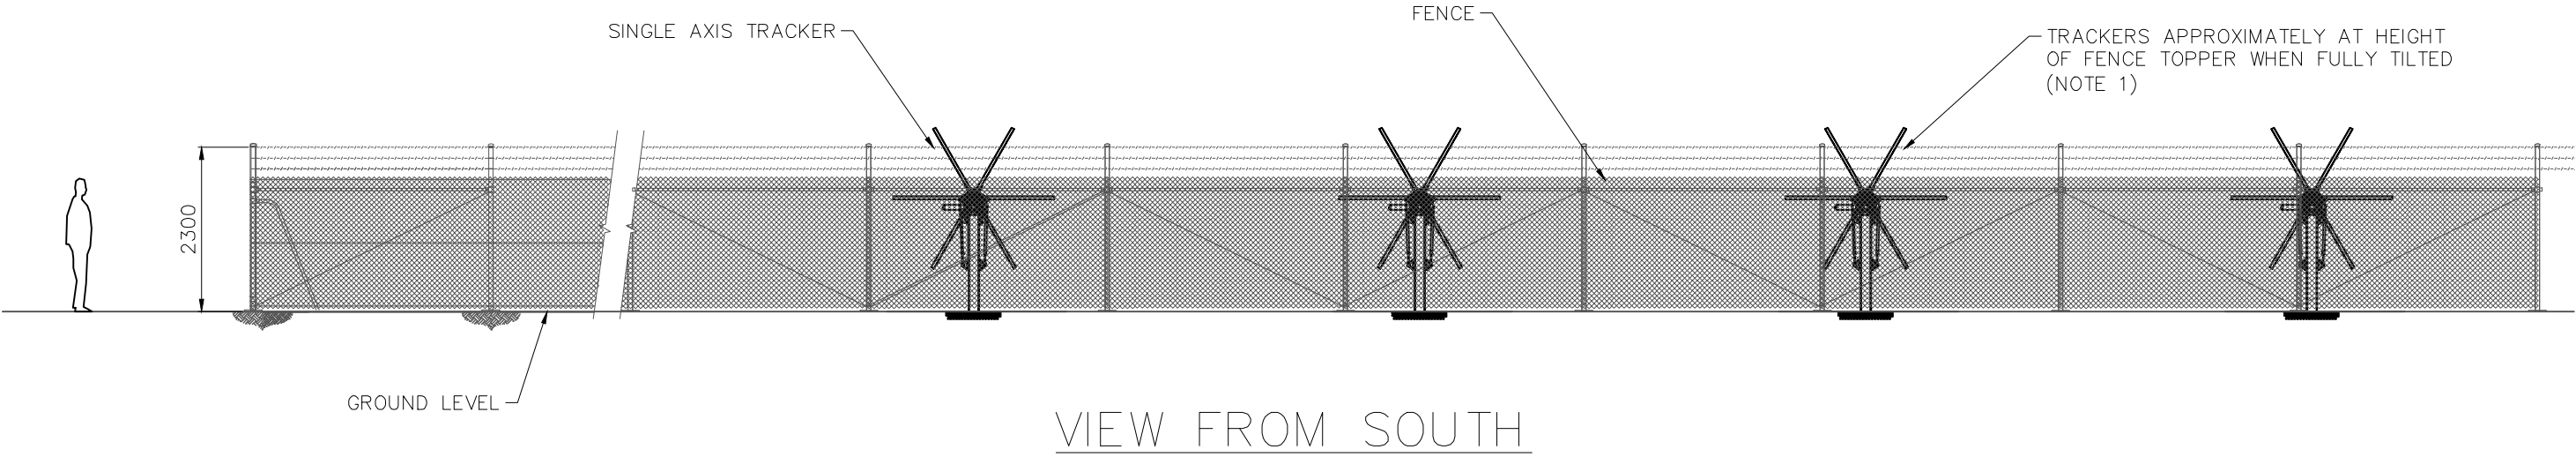


REV.		DATE	DESCRIPTION	DRWN.	DESIGNED	CHKD.	APPR.
REVISIONS	C	2020.12.07	MINOR REVISIONS	JM	JM	SS	JM
	B	2020.12.03	MINOR REVISIONS	JM	JM	SS	JM
	A	2020.11.06	FIRST ISSUE	JM	JM	SS	JM

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TITLE		SCALE
PROVIDENCE ASSET GROUP		DNS
WARRAL SOLAR FARM		REVISION
SITE ELEVATION DETAIL		C
DWG No. 10040-G-DET-01-1		PAPER SIZE
		A3

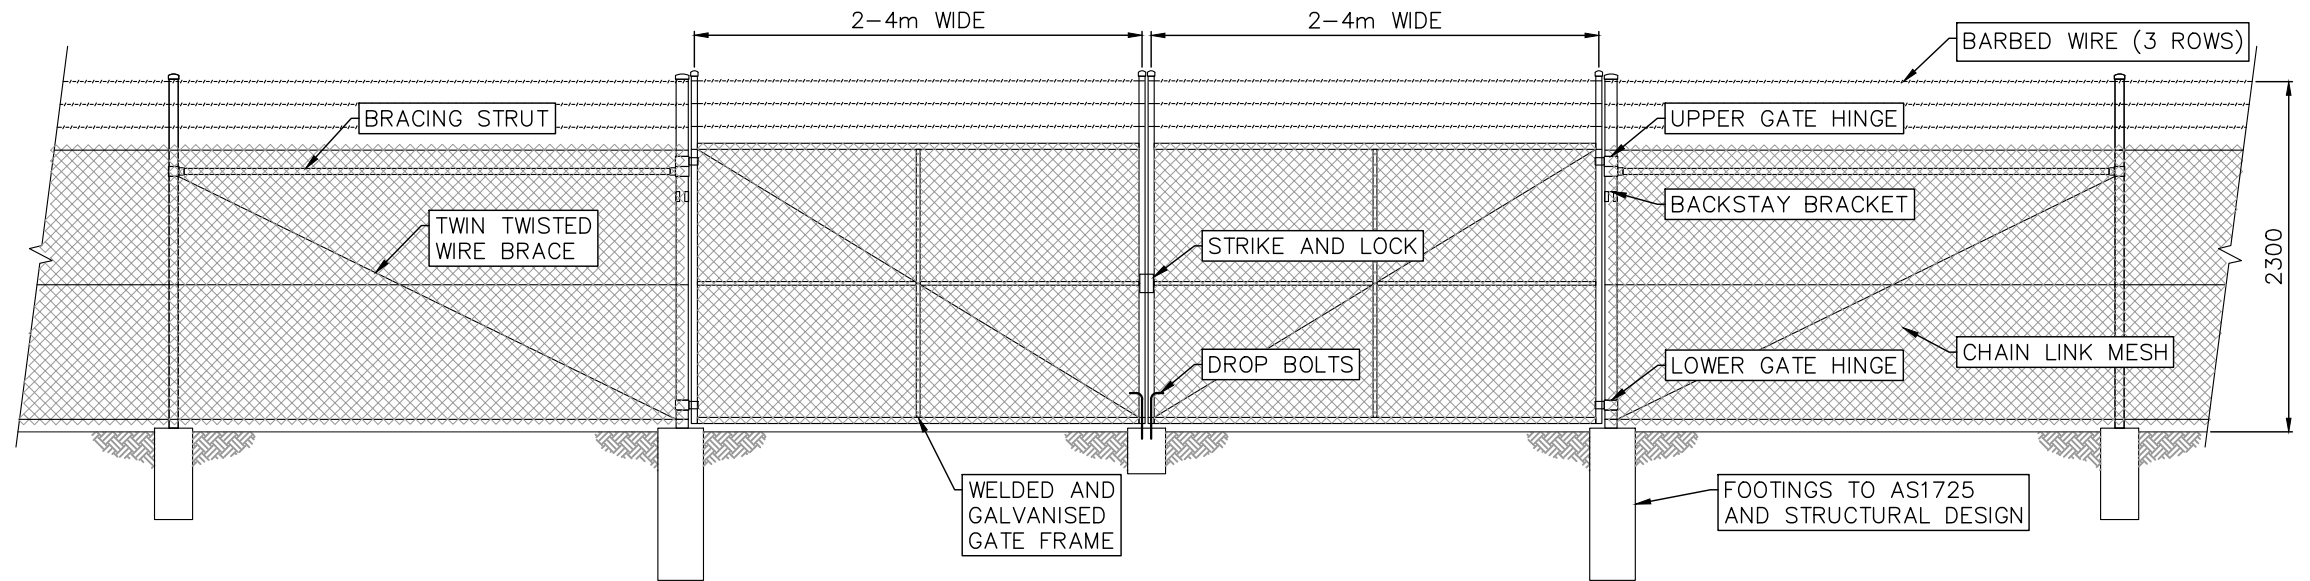

TYPICAL FENCE & GATE ELEVATION

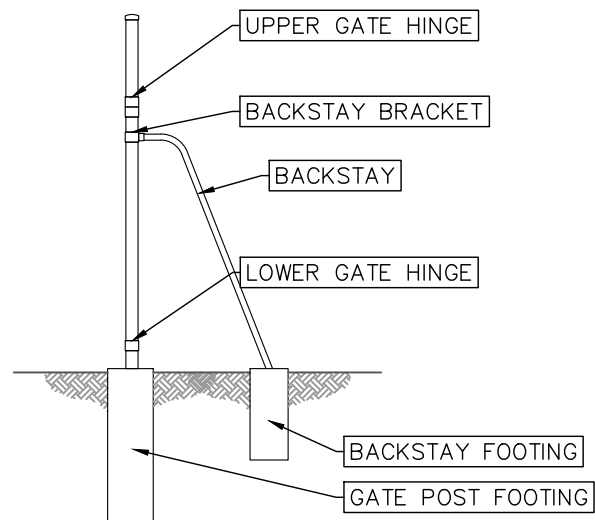

TYPICAL BACKSTAY ELEVATION

GENERAL NOTES


- SOLAR FARM PERIMETER FENCE TO BE GALVANISED CHAIN LINK MESH FENCE WITH 3 ROWS BARBED WIRE.
- NOMINAL MESH HEIGHT TO BE 1800mm.
- NOMINAL OVERALL HEIGHT TO BE 2300mm +/- 100mm.
- ALL FENCING COMPONENTS AND FOOTINGS TO COMPLY WITH AS 1725.
- GATE WIDTH AS PER GA LAYOUT DRAWINGS.
- BRACING STRUT AND WIRE BRACE REQUIRED AT ENDS, CORNERS AND GATES. DIAGONAL BRACE STRUT MAY ALSO BE USED IN LIEU OF BRACE & WIRE.
- INTERMEDIATE BRACED PANEL CONSISTING OF TWIN TWISTED WIRE BRACE ON BOTH DIAGONALS REQUIRED AT MAX. 150m INTERVALS.
- PERSONNEL ACCESS GATES REQUIRE BRACING STRUTS ON BOTH SIDES.
- FOOTING DESIGN TO BE CONFIRMED DURING DETAILED DESIGN.
- FENCE GENERALLY NOT REQUIRED TO BE EARTHED UNLESS IN CLOSE IS PROXIMITY TO ELECTRICAL COMPONENTS OR AS REQUIRED WITHIN UTILITY EASEMENTS OR SIMILAR. TO BE DETERMINED DURING DETAILED DESIGN.

REV.	DATE	DESCRIPTION	DRWN.	DESIGNED	CHKD.	APPR.
C	2020.12.07	MINOR REVISIONS	JM	JM	SS	JM
B	2020.12.04	MINOR REVISIONS	JM	JM	SS	JM
A	2020.10.19	ISSUED FOR INFORMATION	JM	JM	SS	JM

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TITLE
PROVIDENCE ASSET GROUP
WARRAL SOLAR FARM
SECURITY FENCING DETAIL
TYPICAL
DWG No. 10040-C-DET-02-1

SCALE
DNS
REVISION
C
PAPER SIZE
A3

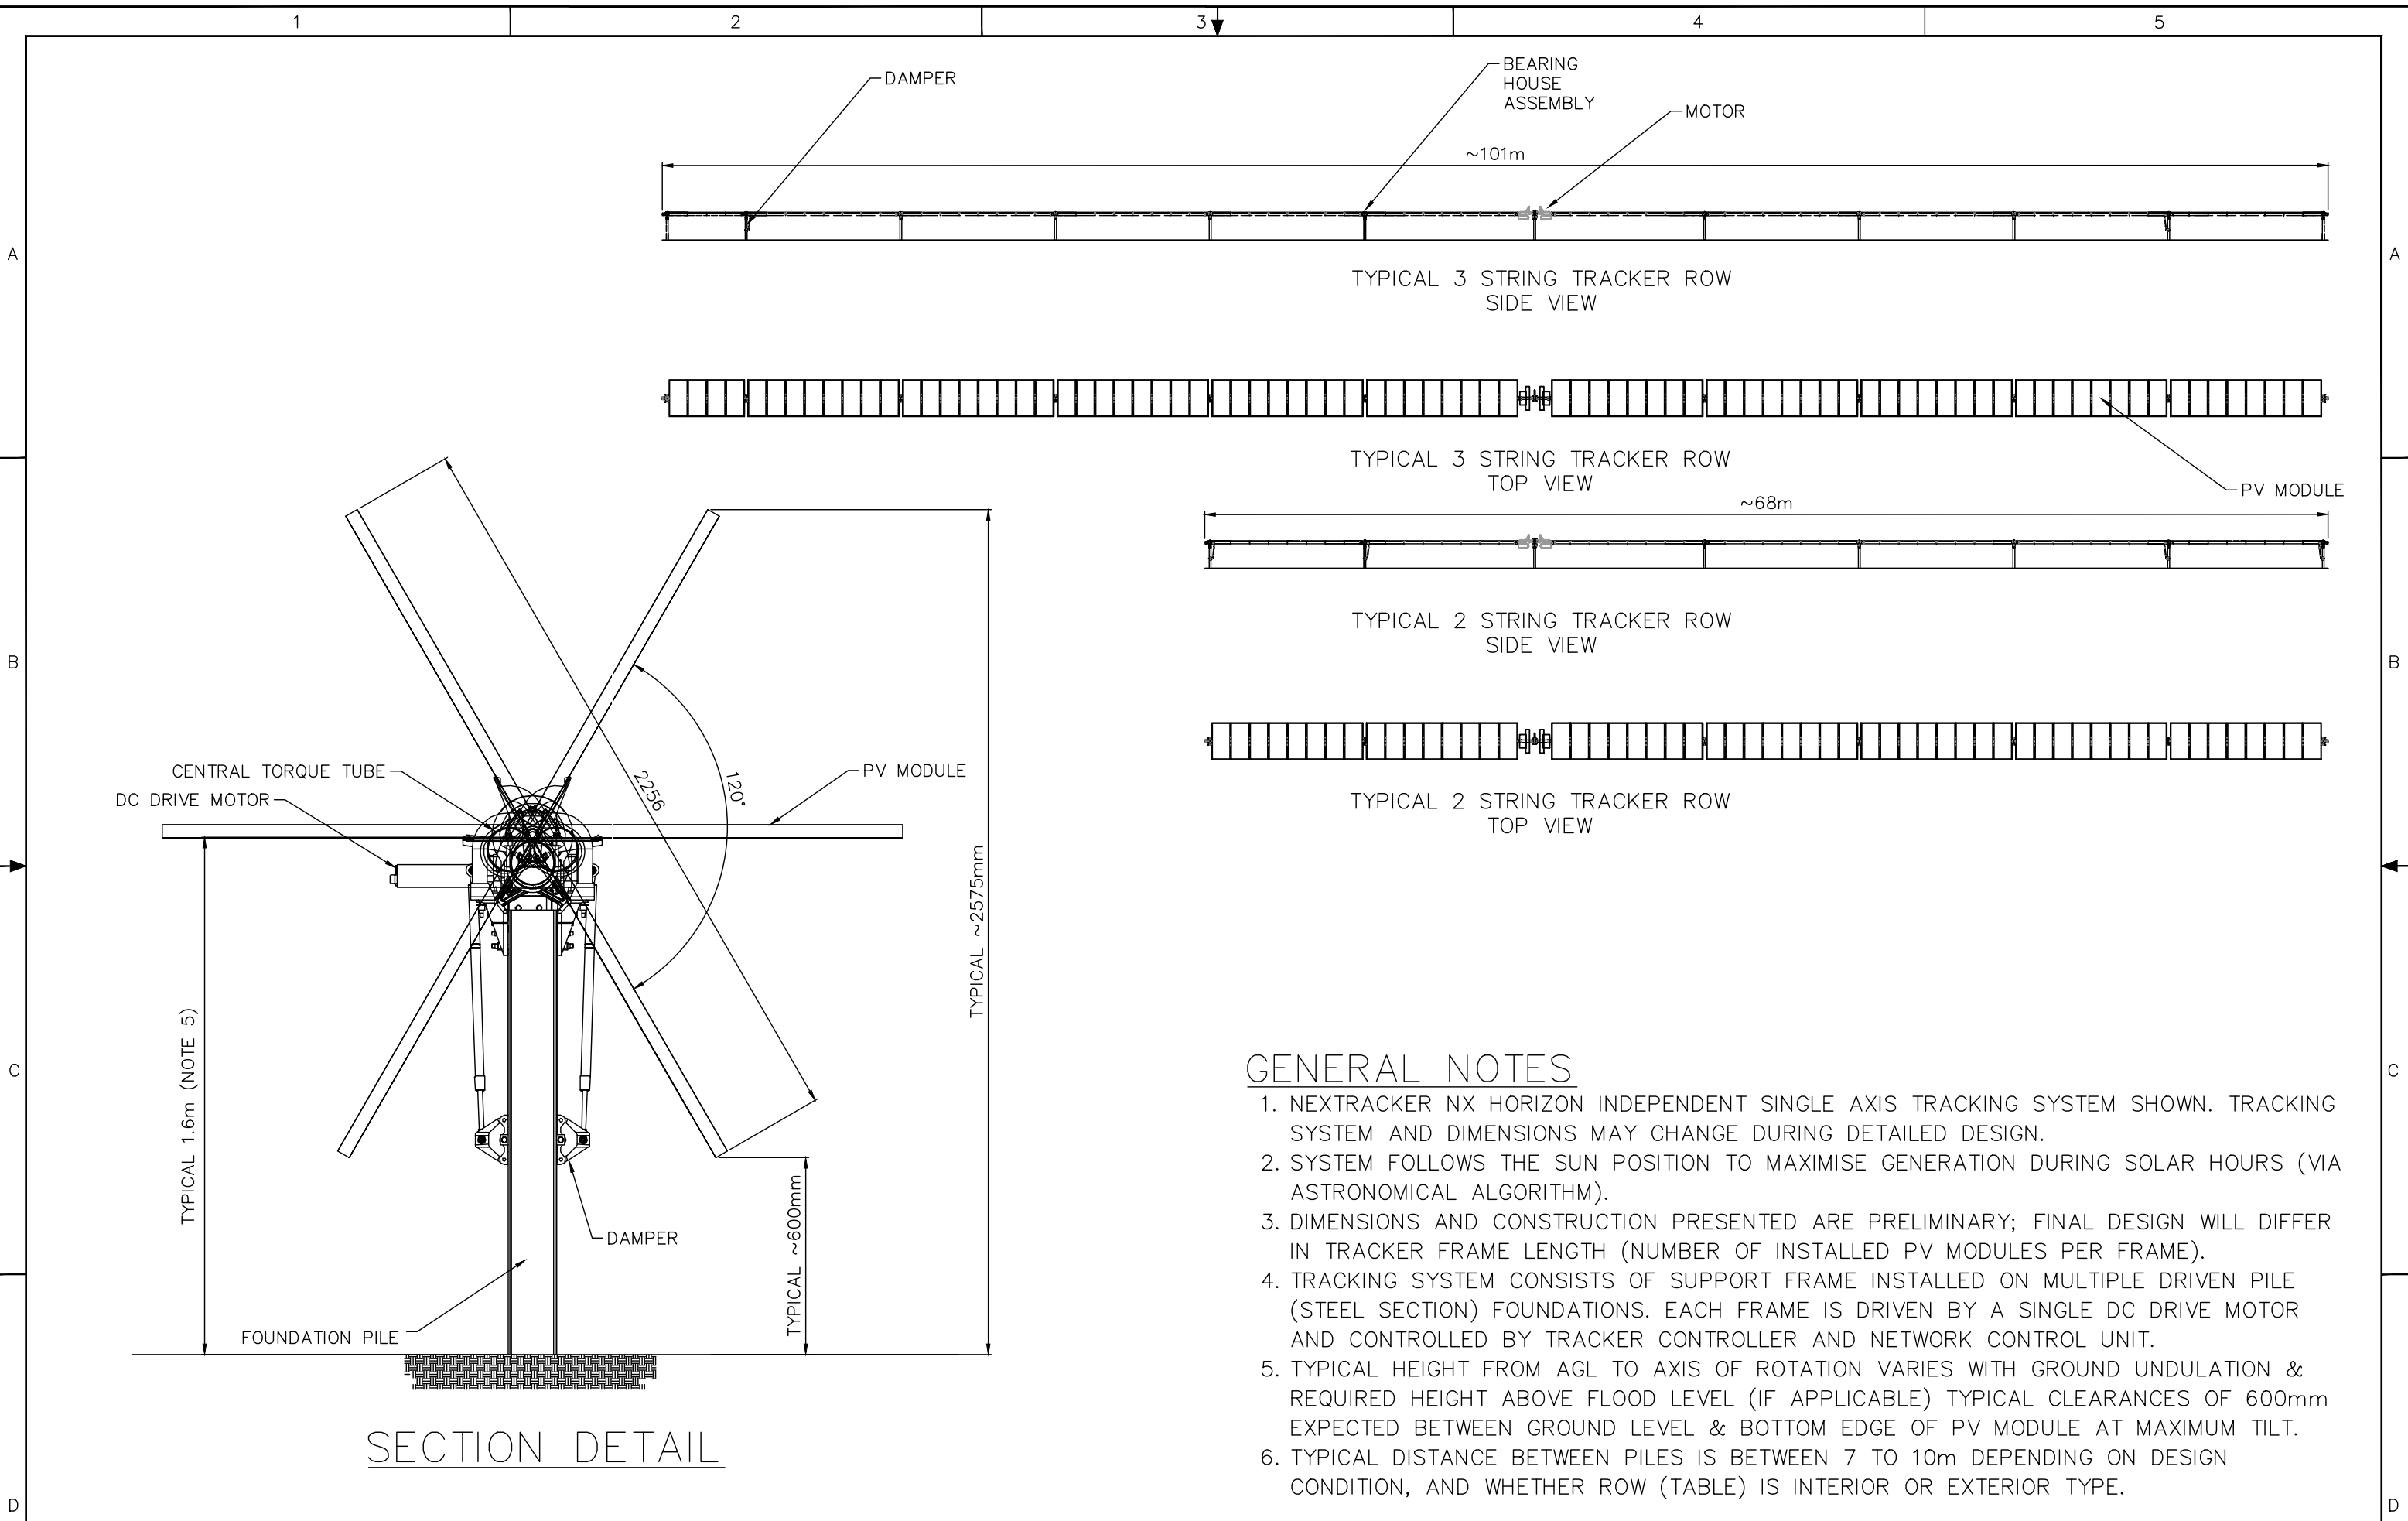

GENERAL NOTES

- 1. NEXTRACKER NX HORIZON INDEPENDENT SINGLE AXIS TRACKING SYSTEM SHOWN. TRACKING SYSTEM AND DIMENSIONS MAY CHANGE DURING DETAILED DESIGN.
- 2. SYSTEM FOLLOWS THE SUN POSITION TO MAXIMISE GENERATION DURING SOLAR HOURS (VIA ASTRONOMICAL ALGORITHM).
- 3. DIMENSIONS AND CONSTRUCTION PRESENTED ARE PRELIMINARY; FINAL DESIGN WILL DIFFER IN TRACKER FRAME LENGTH (NUMBER OF INSTALLED PV MODULES PER FRAME).
- 4. TRACKING SYSTEM CONSISTS OF SUPPORT FRAME INSTALLED ON MULTIPLE DRIVEN PILE (STEEL SECTION) FOUNDATIONS. EACH FRAME IS DRIVEN BY A SINGLE DC DRIVE MOTOR AND CONTROLLED BY TRACKER CONTROLLER AND NETWORK CONTROL UNIT.
- 5. TYPICAL HEIGHT FROM AGL TO AXIS OF ROTATION VARIES WITH GROUND UNDULATION & REQUIRED HEIGHT ABOVE FLOOD LEVEL (IF APPLICABLE) TYPICAL CLEARANCES OF 600mm EXPECTED BETWEEN GROUND LEVEL & BOTTOM EDGE OF PV MODULE AT MAXIMUM TILT.
- 6. TYPICAL DISTANCE BETWEEN PILES IS BETWEEN 7 TO 10m DEPENDING ON DESIGN CONDITION, AND WHETHER ROW (TABLE) IS INTERIOR OR EXTERIOR TYPE.

REV.		DATE	DESCRIPTION	DRWN.	DESIGNED	CHKD.	APPR.
REVISONS	D	2020.12.07	MINOR REVISIONS	JM	JM	SS	JM
	C	2020.11.23	RE-ISSUED WITH CHANGES	JM	JM	SS	JM
	B	2020.11.18	RE-ISSUED WITH CHANGES	JM	JM	SS	JM
	A	2020.10.19	FIRST ISSUE	JM	JM	SS	JM

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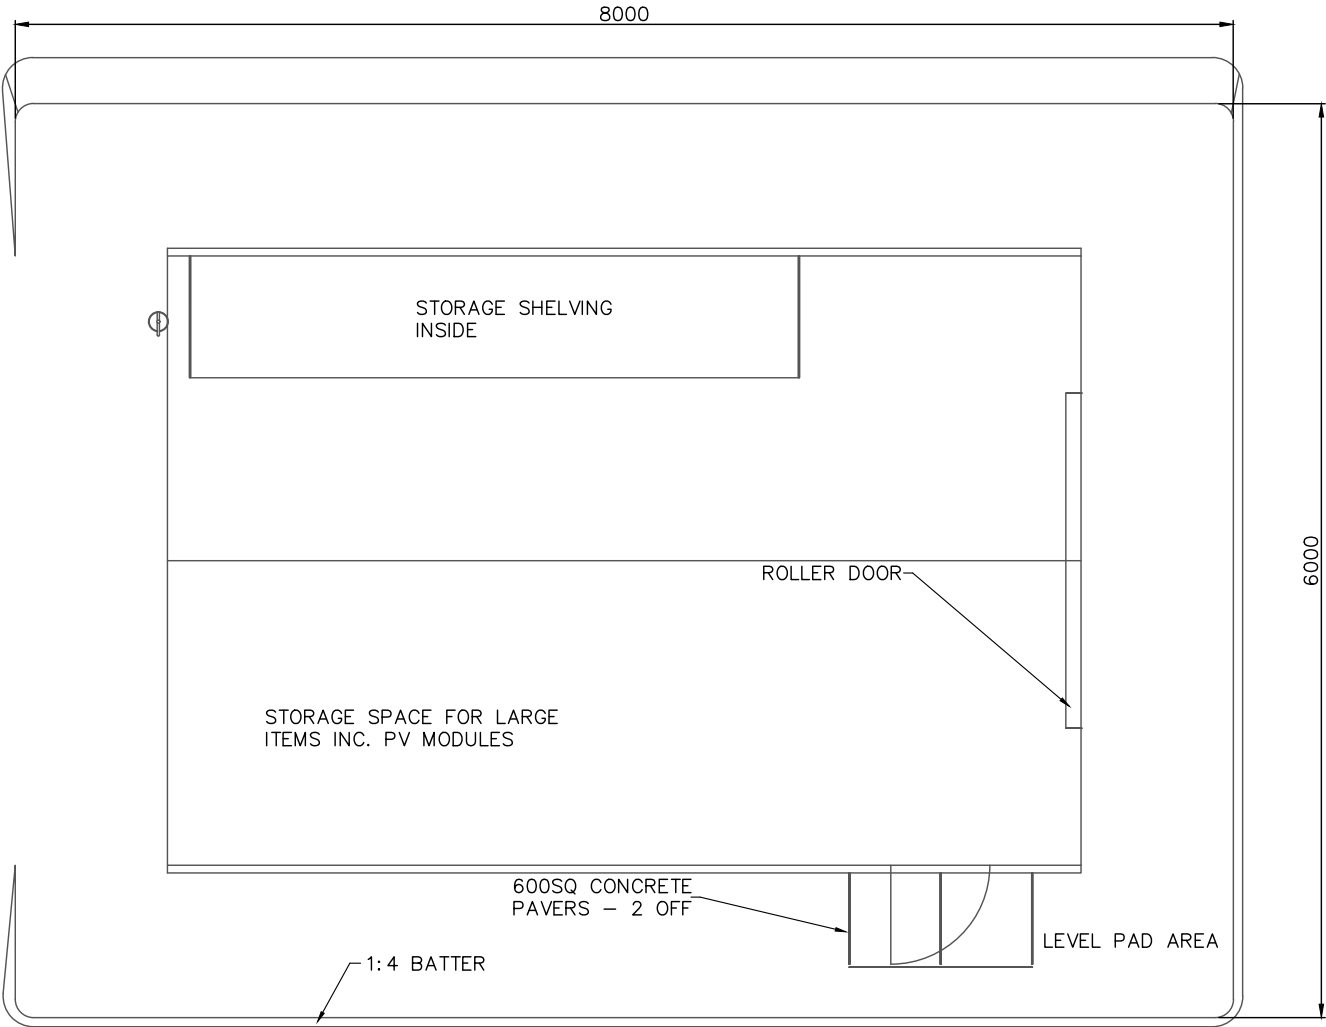
TITLE
PROVIDENCE ASSET GROUP
WARRAL SOLAR FARM
PV MOUNTING SYSTEM DETAIL

DWG No. 10040-E-DET-01-1


SCALE
DNS
REVISION
D
PAPER SIZE
A3

GENERAL NOTES:

- 1. DIMENSIONS ARE SHOWN IN MILLIMETERS (mm)
- 2. SHED DESIGNED AND SUPPLIED BY (TBC).
- 3. WIND REGION A1, IMPORTANCE LEVEL 2
- 4. COMPLIES WITH PART B1 OF BUILDING CODE OF AUSTRALIA



PLAN

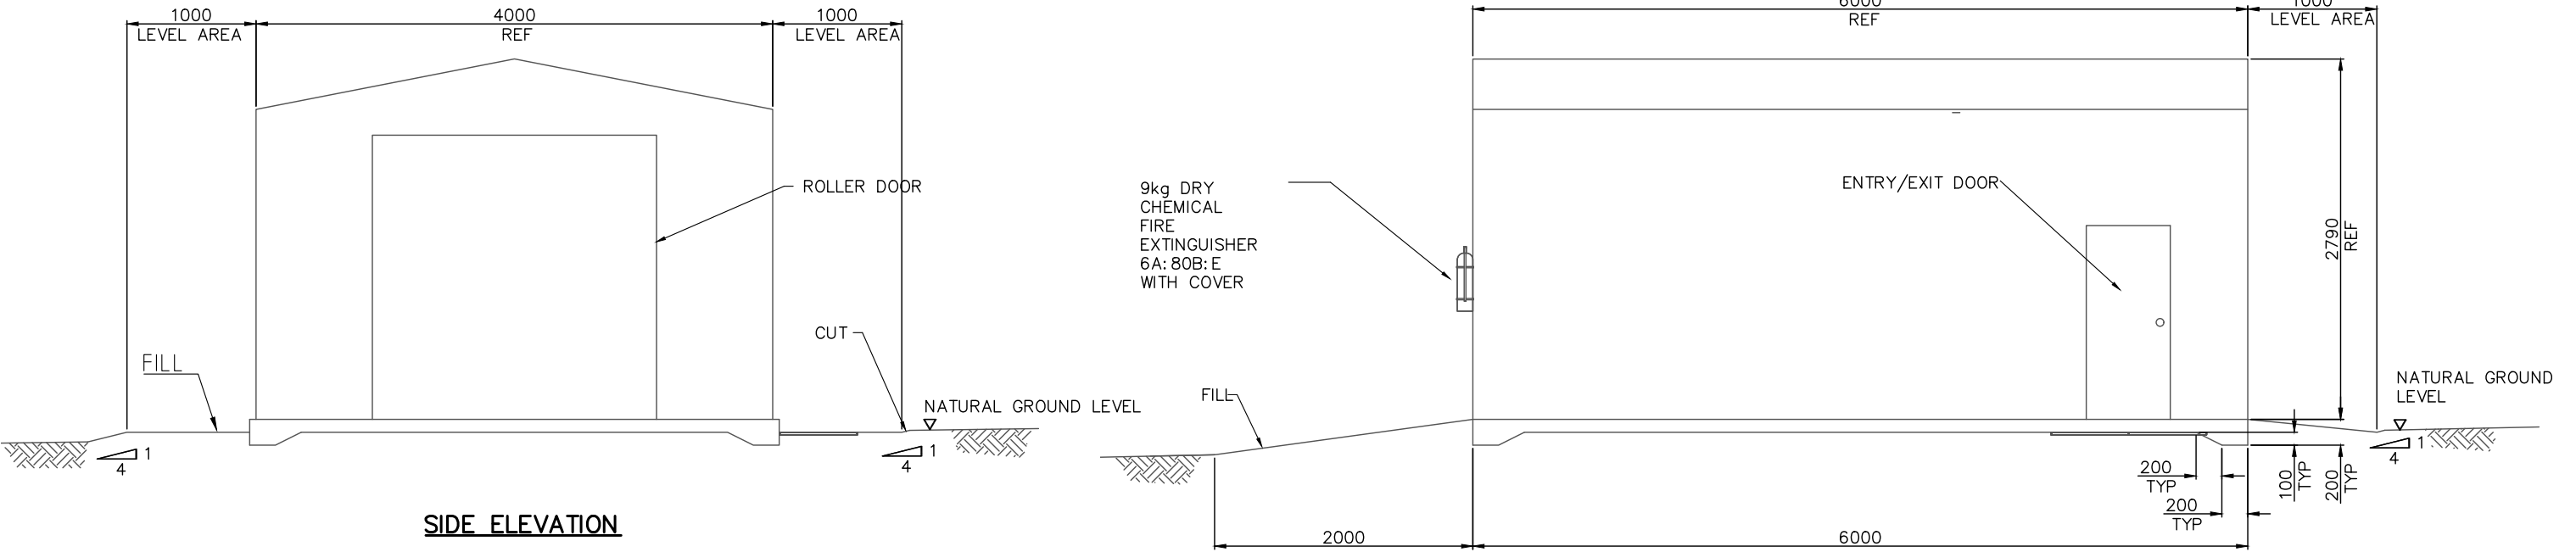

SIDE ELEVATION

ELEVATION



REFERENCES

REVISIONS

REV.	DATE	DESCRIPTION	DRWN.	DESIGNED	CHKD.	APPR.	



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TITLE	PROVIDENCE ASSET GROUP
	WARRAL SOLAR FARM
	SHED DETAIL
	TYPICAL
DWG No.	10040-C-DET-05-1

SCALE	AS SHOWN
REVISION	C
PAPER SIZE	A3

7. LANDSCAPE CONCEPT



7.1 Landscape Plan

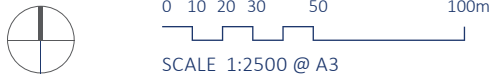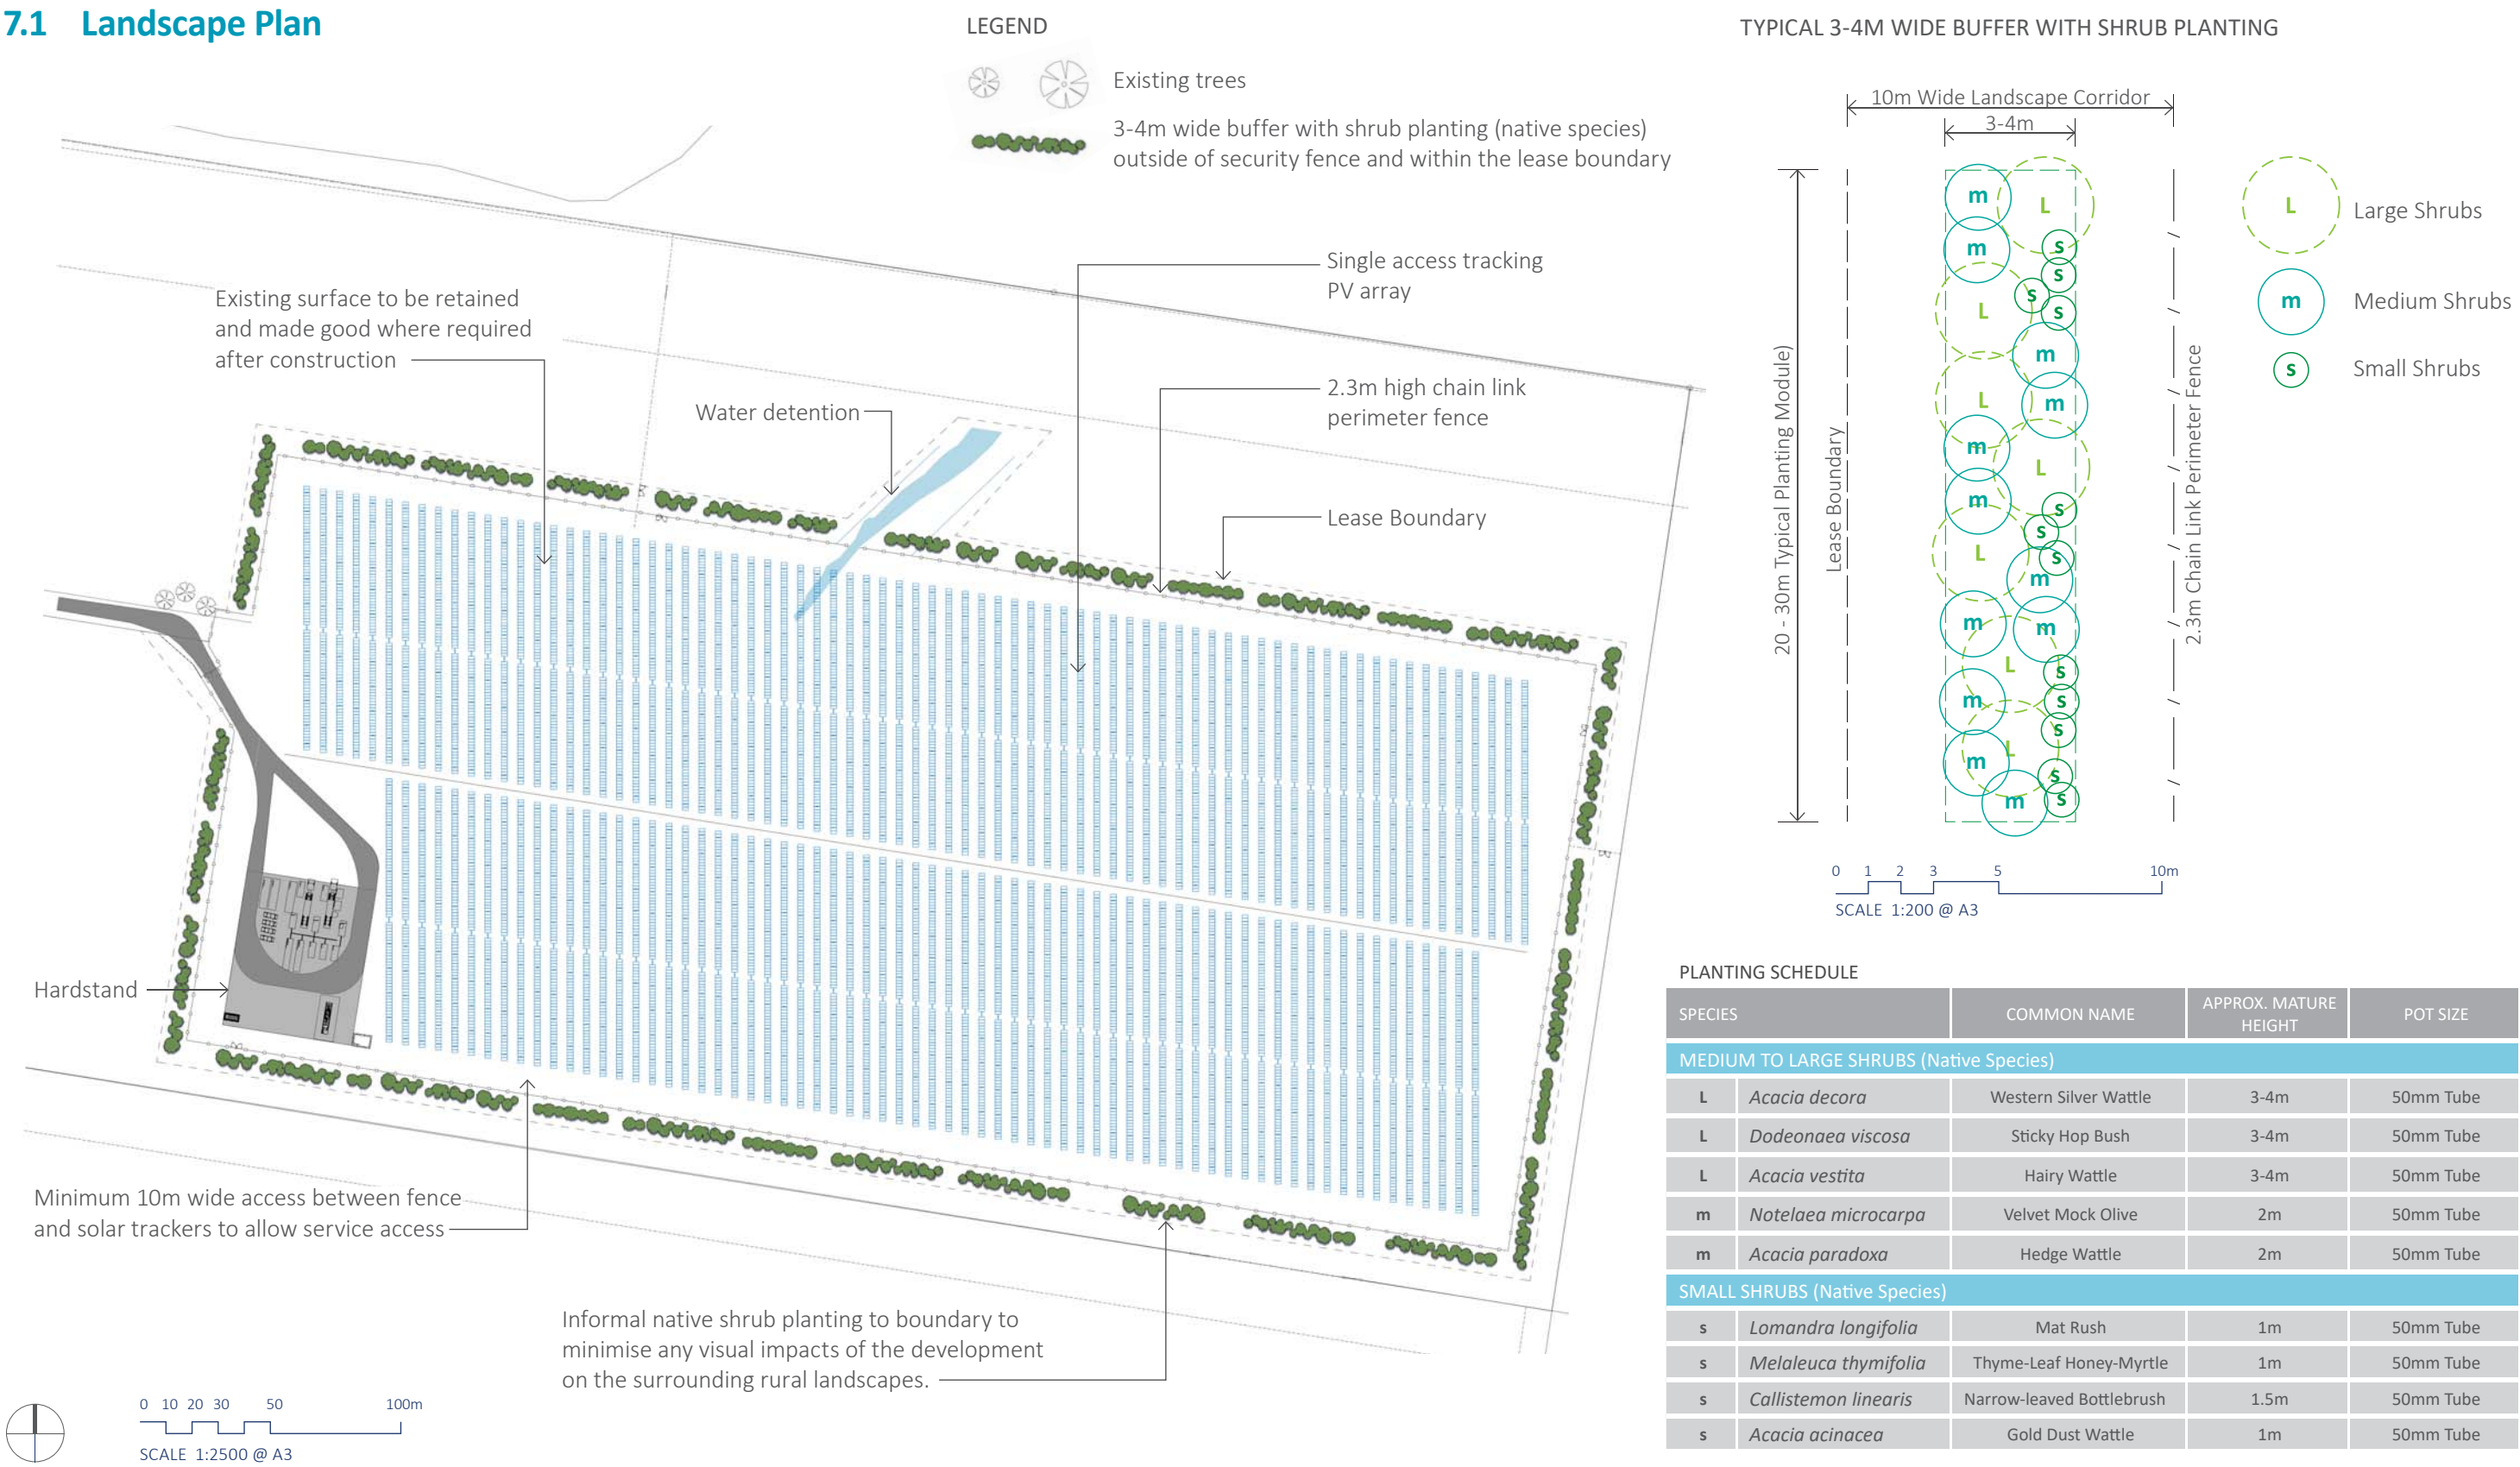


7.2 Landscape Screening



TYPICAL VEGETATION BUFFER (FRONT ELEVATION)

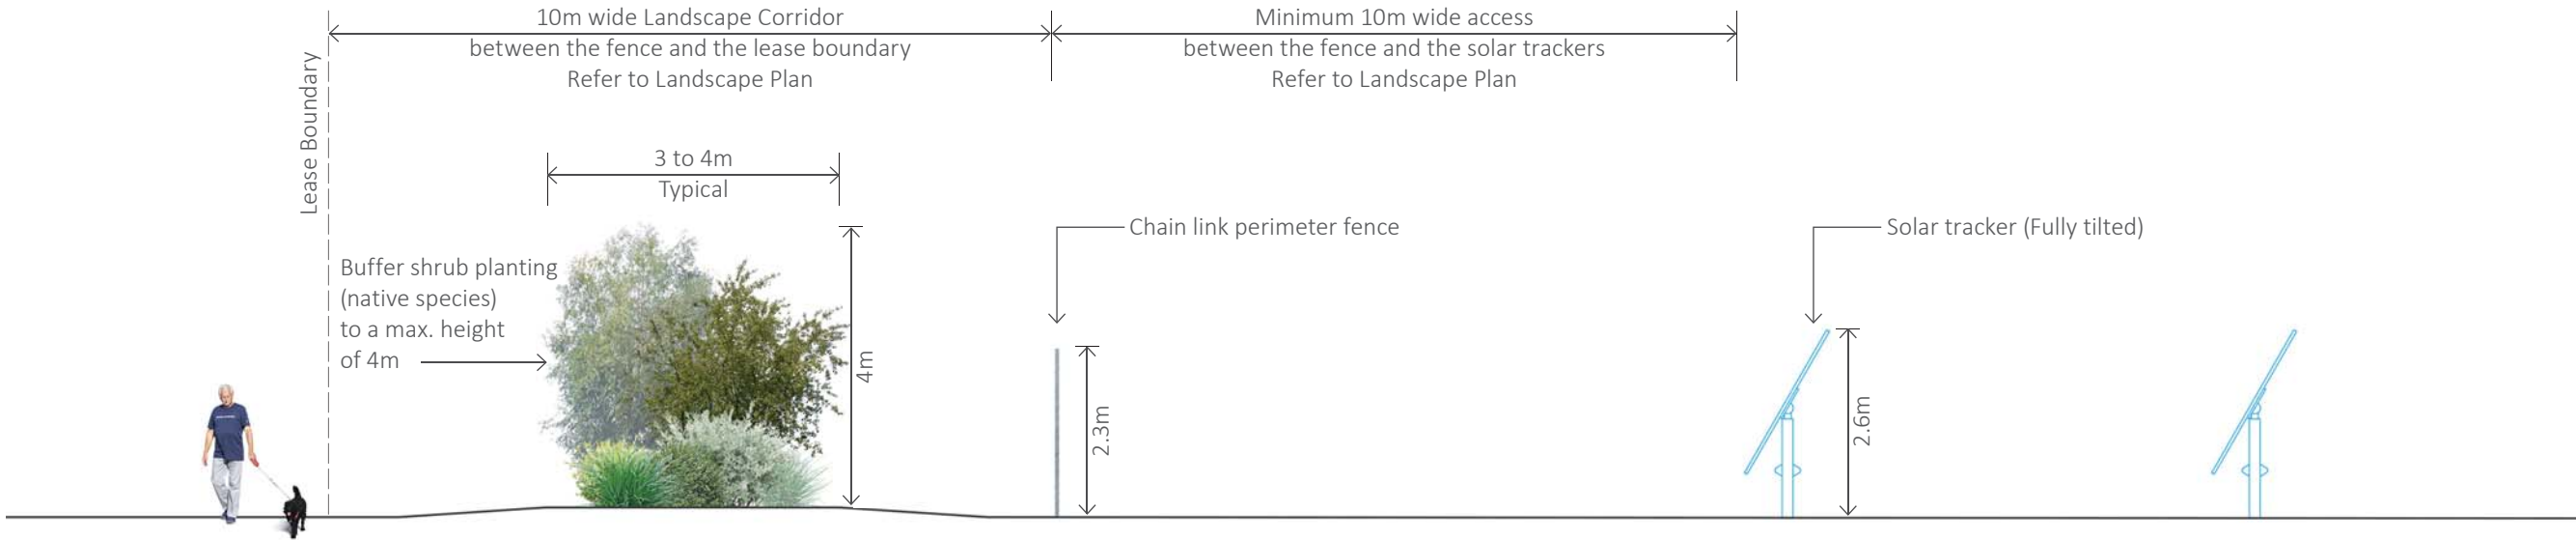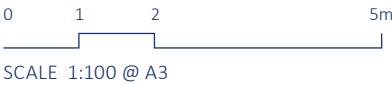

TYPICAL VEGETATION BUFFER SECTION

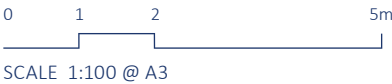

7.3 Landscape Works Construction Notes

The following outline of Landscape Works to be undertaken by the Landscape Contractor (unless otherwise stated). This will not override future detail documentation that will be undertaken as part of the project works, prior to construction.

7.3.1 Civil Works

The EPC Contractor will ensure the following minimum depths of site topsoil are provided.

- Planting areas to be a minimum 200 mm depth site topsoil.
- Grass/ turf areas to be a minimum of 100mm site topsoil
- Finished level of topsoil to be generally 100-150 mm above surrounding existing ground surface levels to ensure topsoil/planting areas are free from water-logging.

7.3.2 Locate Existing Services

The Landscape Contractor shall locate all existing services prior to commencing works, contacting Dial Before You Dig, the project EPC Contractor and/or the relevant authorities as required. Identify all overhead services prior to commencing works.

7.3.3 Set Out the Works

The Landscape Contractor shall accurately set the works out in accordance with the future detailed documentation set.

7.3.4 Soil Testing

The Landscape Contractor shall undertake soil sampling & testing of the existing topsoil as stripped and stockpiled by the EPC Contractor. An approved agricultural soil testing laboratory shall be used to test and provide amelioration recommendations for the soil shall be in accordance with AS 4419:2018 Soils for landscaping and garden use. Any recommended adjustments must be made for native tree & shrub planting.

7.3.5 Planting Areas Preparation

The Landscape Contractor shall undertake the planting preparation works in line with best practice, consideration of local conditions and timing of the works.

Eradicate broad-leaf, woody and noxious weeds from all planting areas using selective, non-residual herbicides. Manual removal of larger woody weeds may be required. Inspect the site prior to commencement to confirm extent of weed treatment and follow up with secondary treatment if required.

- If the existing soil is heavily compacted, deep rip along planting line to minimum 300 mm depth with tines at a maximum of 750 mm centres to break up/aerate natural subgrade and to relieve compaction, grade & level.
- Apply fertilisers and additives at rates recommended by soil test results.
- Cultivate planting lines to a minimum of 150mm depth to break up soil clods and provide an appropriate planting medium. Re-cultivate planting lines to break up soil clods and provide an appropriate planting medium if required.
- Remove any deleterious material brought to the surface, consolidate soil and grade surface to even grades, free of any depressions or undulations.
- DO NOT WORK WET SOIL.

7.3.6 Plant Supply

All plants shall be healthy, free from any pests or diseases, be attractive, well grown and well-formed plant specimens (typical of the individual species) and shall have a healthy, well-formed root system commensurate in size with the foliage mass (root systems must not be pot bound). Plant container sizes shall be as listed in the detail planting schedule, but shall be min. hiko, ViroTube or 50 mm round/square pot size.

7.3.7 Planting

The Landscape Contractor shall set out plants in accordance with future detailed documentation. Individual holes are to be dug (tree planter, mini-auger, etc.) in the prepared planting areas of sufficient size to easily accommodate the plant’s root system and relieve any polishing. Create broad, shallow watering bowl to ALL plants to facilitate effective watering (min. 15 litre capacity). All plants shall be watered-in immediately after planting and at such times during the Contract period as is required to maintain growth free of water stress. Planting medium must be moist - do not plant into dry soil. Handle and plant all plants at all times in accordance with best horticultural practice.

7.3.8 Mulch

The Landscape Contractor shall supply and place 100mm organic mulch to all new planted areas. Preference is for Forest Mulch or local tub-ground mulch where possible. Mulch shall be free of deleterious material such as rubbish, soil, stones and large sticks.

7.3.9 Weed Mats

Where weed matting is to be used, the Landscape Contractor is to supply & install proprietary (TreeMax or similar approved) jute weed mat to each plant. Installation shall be strictly in accordance with manufacturer’s recommendations.

7.3.10 Tree / Plant Guides

Where tree/ plant guards are to be used, the Landscape Contractor is to supply & install proprietary tree guards (TreeMax or similar approved) to all nominated plants. Installation shall be strictly in accordance with manufacturer’s recommendations.

7.3.11 Grassing (Where Required)

Where grass works are required (grass seeding or turfing), the Landscape Contractor is to supply and install the specific grass treatment.

Do not sow seed in periods of extreme heat, cold or wet, or where wind velocities are excessive unless otherwise approved.

Seeding shall be programmed when there is a period of anticipated weather conditions (i.e. rain) that will provide the best chance for germination of grass seed. Any areas affected by heavy rain, wind removing seed or other cause shall be re-seeded as specified to achieve an even cover of grass.

Slash grass when growth height has reached 100 mm or otherwise as directed by Council. Should all the areas not require cutting at one time, complete all further cuts as necessary until 100% of the area has achieved successful coverage and all areas have received at least first cut.


7.3.12 Landscape Establishment / Maintenance Period

Landscaping Contractor shall be responsible for maintenance of the landscaping from planting until final project completion and handover to the asset owner (approximately 2 years). Following handover, the site O&M contractor shall be responsible for maintenance and replacement for the lifetime of the asset.

Maintenance shall include care of the contract area by accepted horticultural practices, and rectification of any issues which arise during this period. Maintenance tasks to be carried out as required during the maintenance period shall include (but shall not be limited to) slashing/ mowing, watering, weed control, pest & disease control/ management, tree guard adjustment/ replacement and rubbish removal. Plant establishment at the end of the Maintenance Period is to achieve a minimum 90% success rate.

- WEED CONTROL - Planted areas are to be maintained in a weed-free condition.
- GRASS MANAGEMENT - Slash all grass areas on a regular basis to maintain grass height to max. 100 mm. Slashing shall comply with all local Council and RFS guidelines with regard to grass heights.
- JUTE MAT & PLANT GUARDS - Maintain jute mat and tree guards for first two summers minimum, repair and replace as required during this period.
- PLANT REPLACEMENT - Replace any failing, failed, or dead plants during the maintenance period. The Council and the Contractor will inspect the full planting areas at the end of each summer and will identify the number and species of plants that are failing, have failed/died for replacement

- WATERING - Ensure all plants planted/maintained under this contract receive adequate (but not excessive) watering to maintain optimum growth and health. Watering shall be localised to each plant, not broad spraying across the entire planting area, to limit weed/grass growth between planting rows.
- FERTILISING - All plants shall be fertilised with an approved proprietary fertiliser suitable for native gardens (in particular members of the Proteacea family and plant species and to be applied in strict accordance with the manufacturer’s recommended rates. Fertiliser shall be locally spread on soil surface around plants during planting operations. Allow for one fertiliser application in Year 1 and second application in Year 2.
- PESTS & DISEASES - Regularly monitor all planted and grassed areas maintained under the contract for evidence of pest and/or disease attack. Identify and treat any/all problems arising. Identify any predation by rabbits, hares and other pests with potential to damage or destroy the landscape works under this contract and maintain all tree guards in good condition to limit such damage.

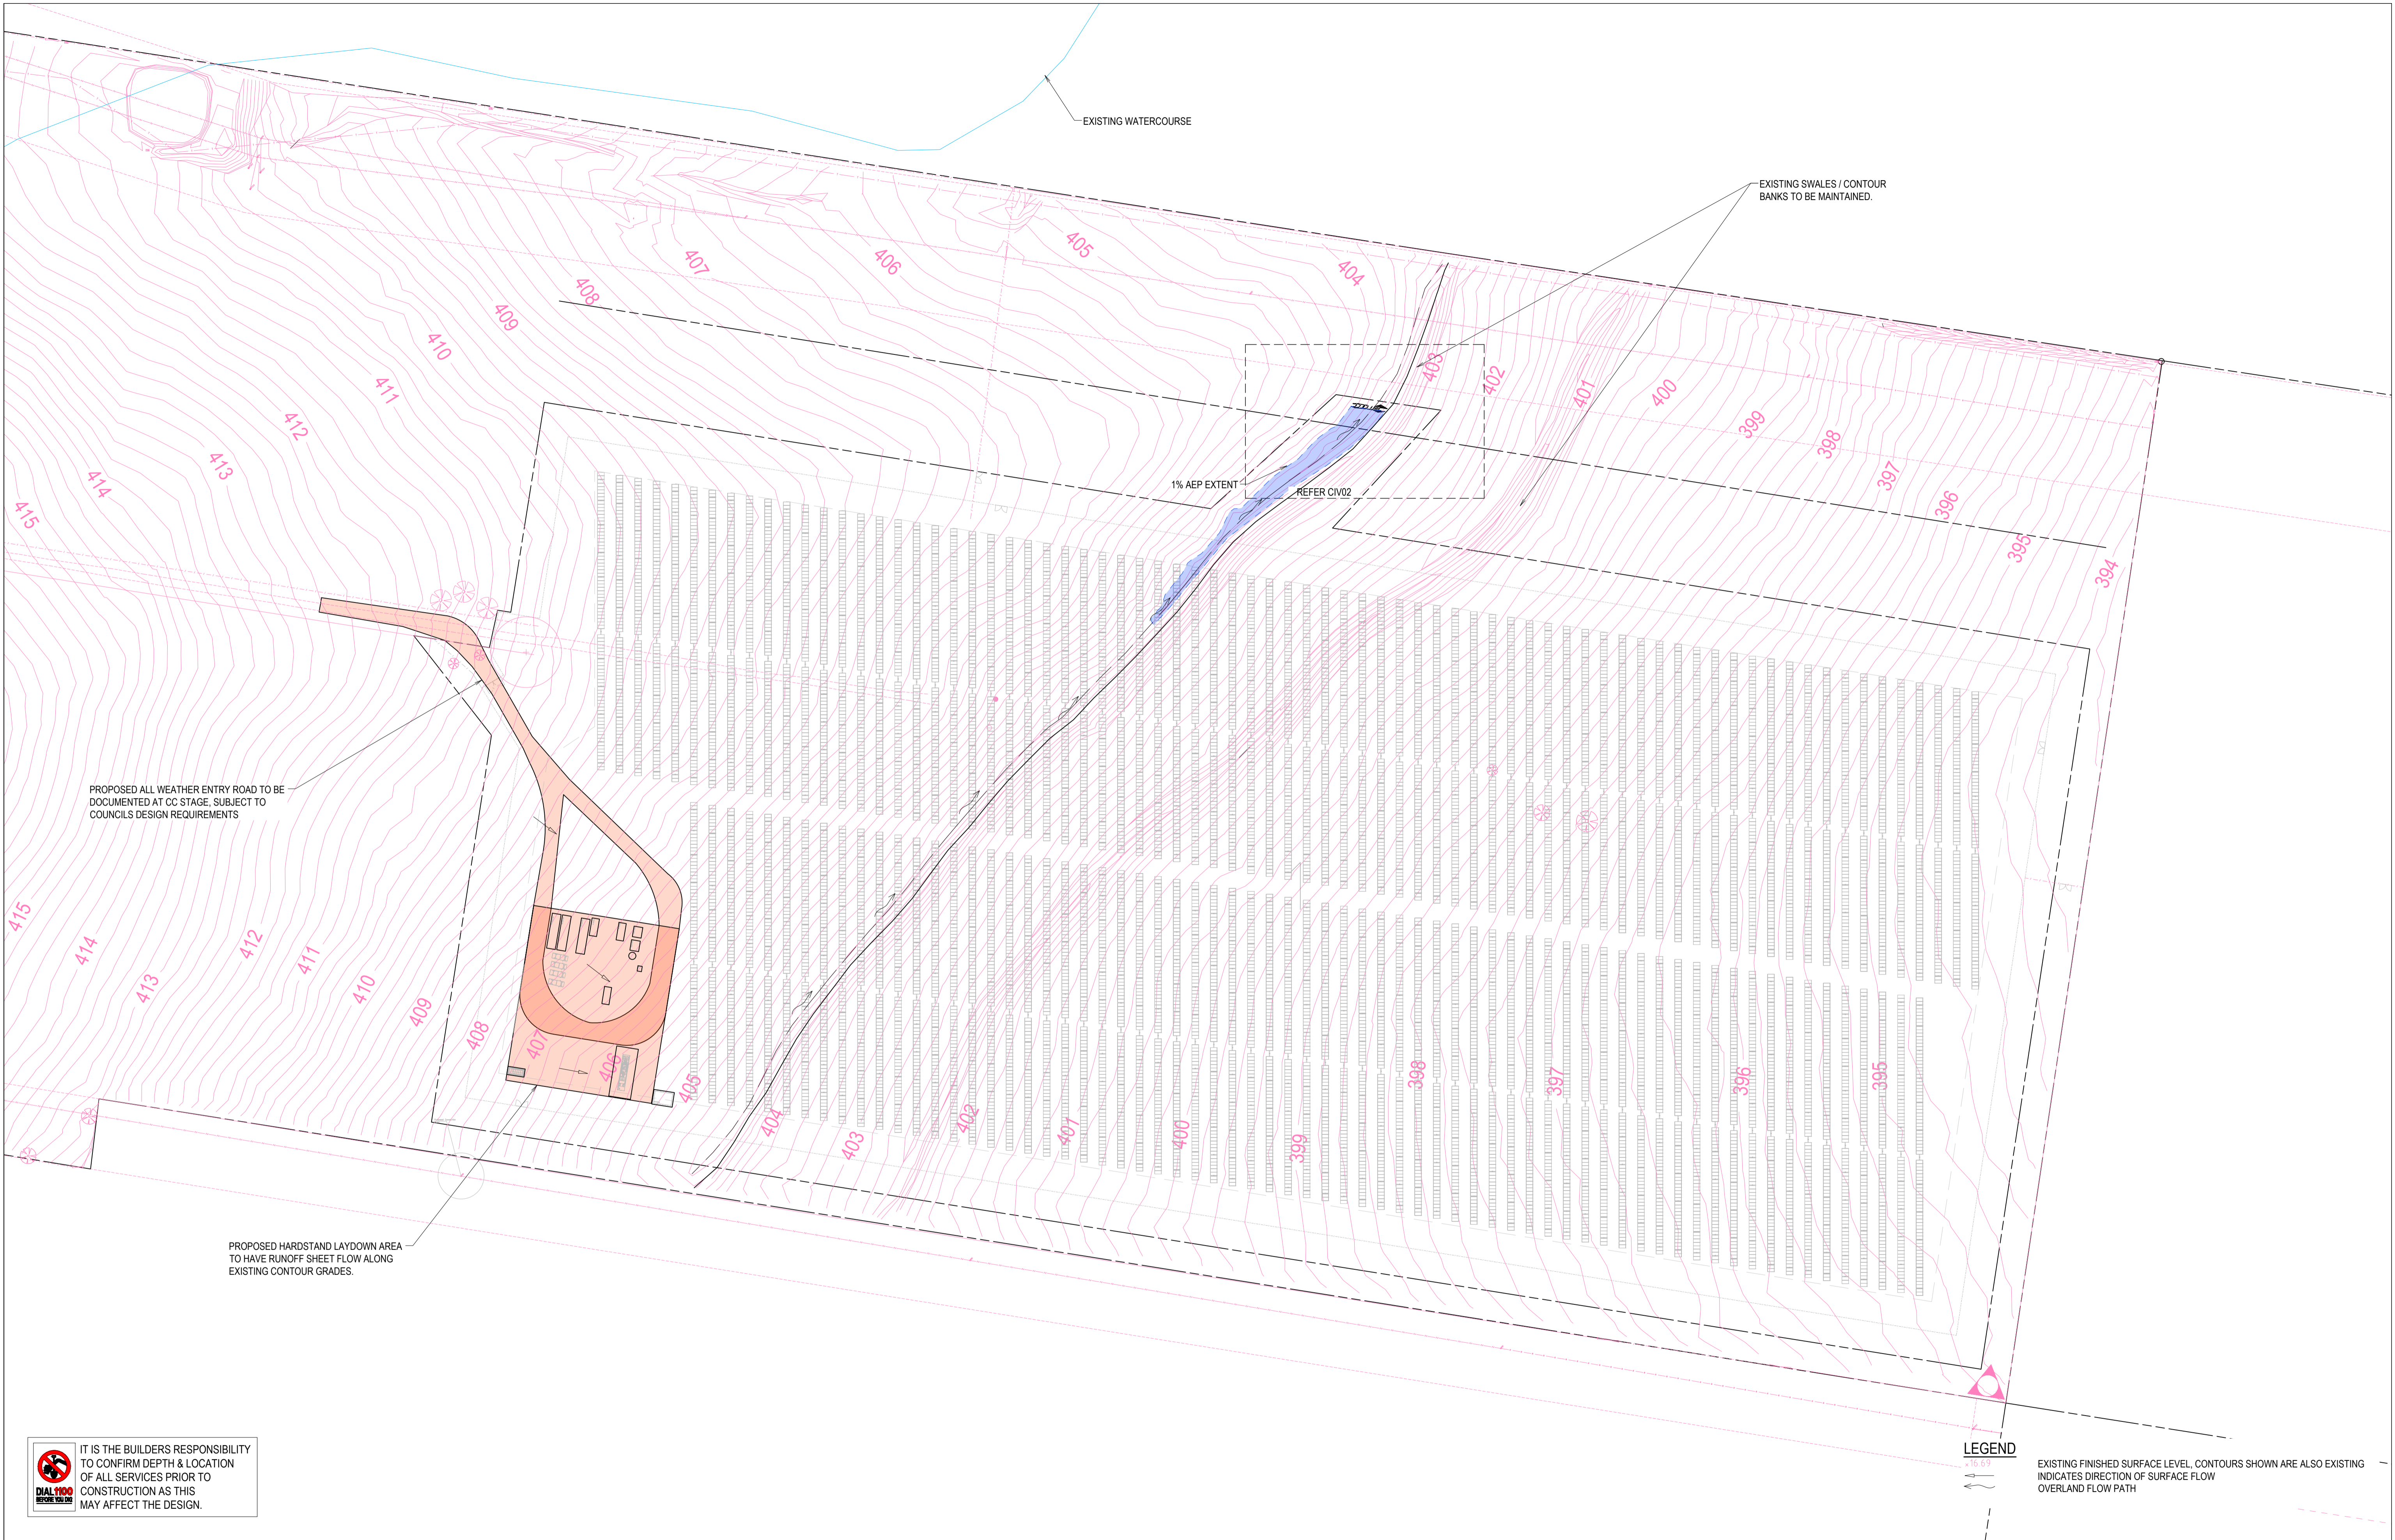


IT IS THE BUILDERS RESPONSIBILITY TO CONFIRM DEPTH & LOCATION OF ALL SERVICES PRIOR TO CONSTRUCTION AS THIS MAY AFFECT THE DESIGN.

REVISIONS					
REV	DATE	DRN	CHK	APP	DRAWING STATUS
C	10.01.20	F.M.	M.M.	M.M.	REISSUED FOR DA
B	04.12.20	F.M.	M.M.	M.M.	ISSUED FOR DA
A	30.11.20	F.M.	M.M.	M.M.	ISSUED FOR CLIENT REVIEW

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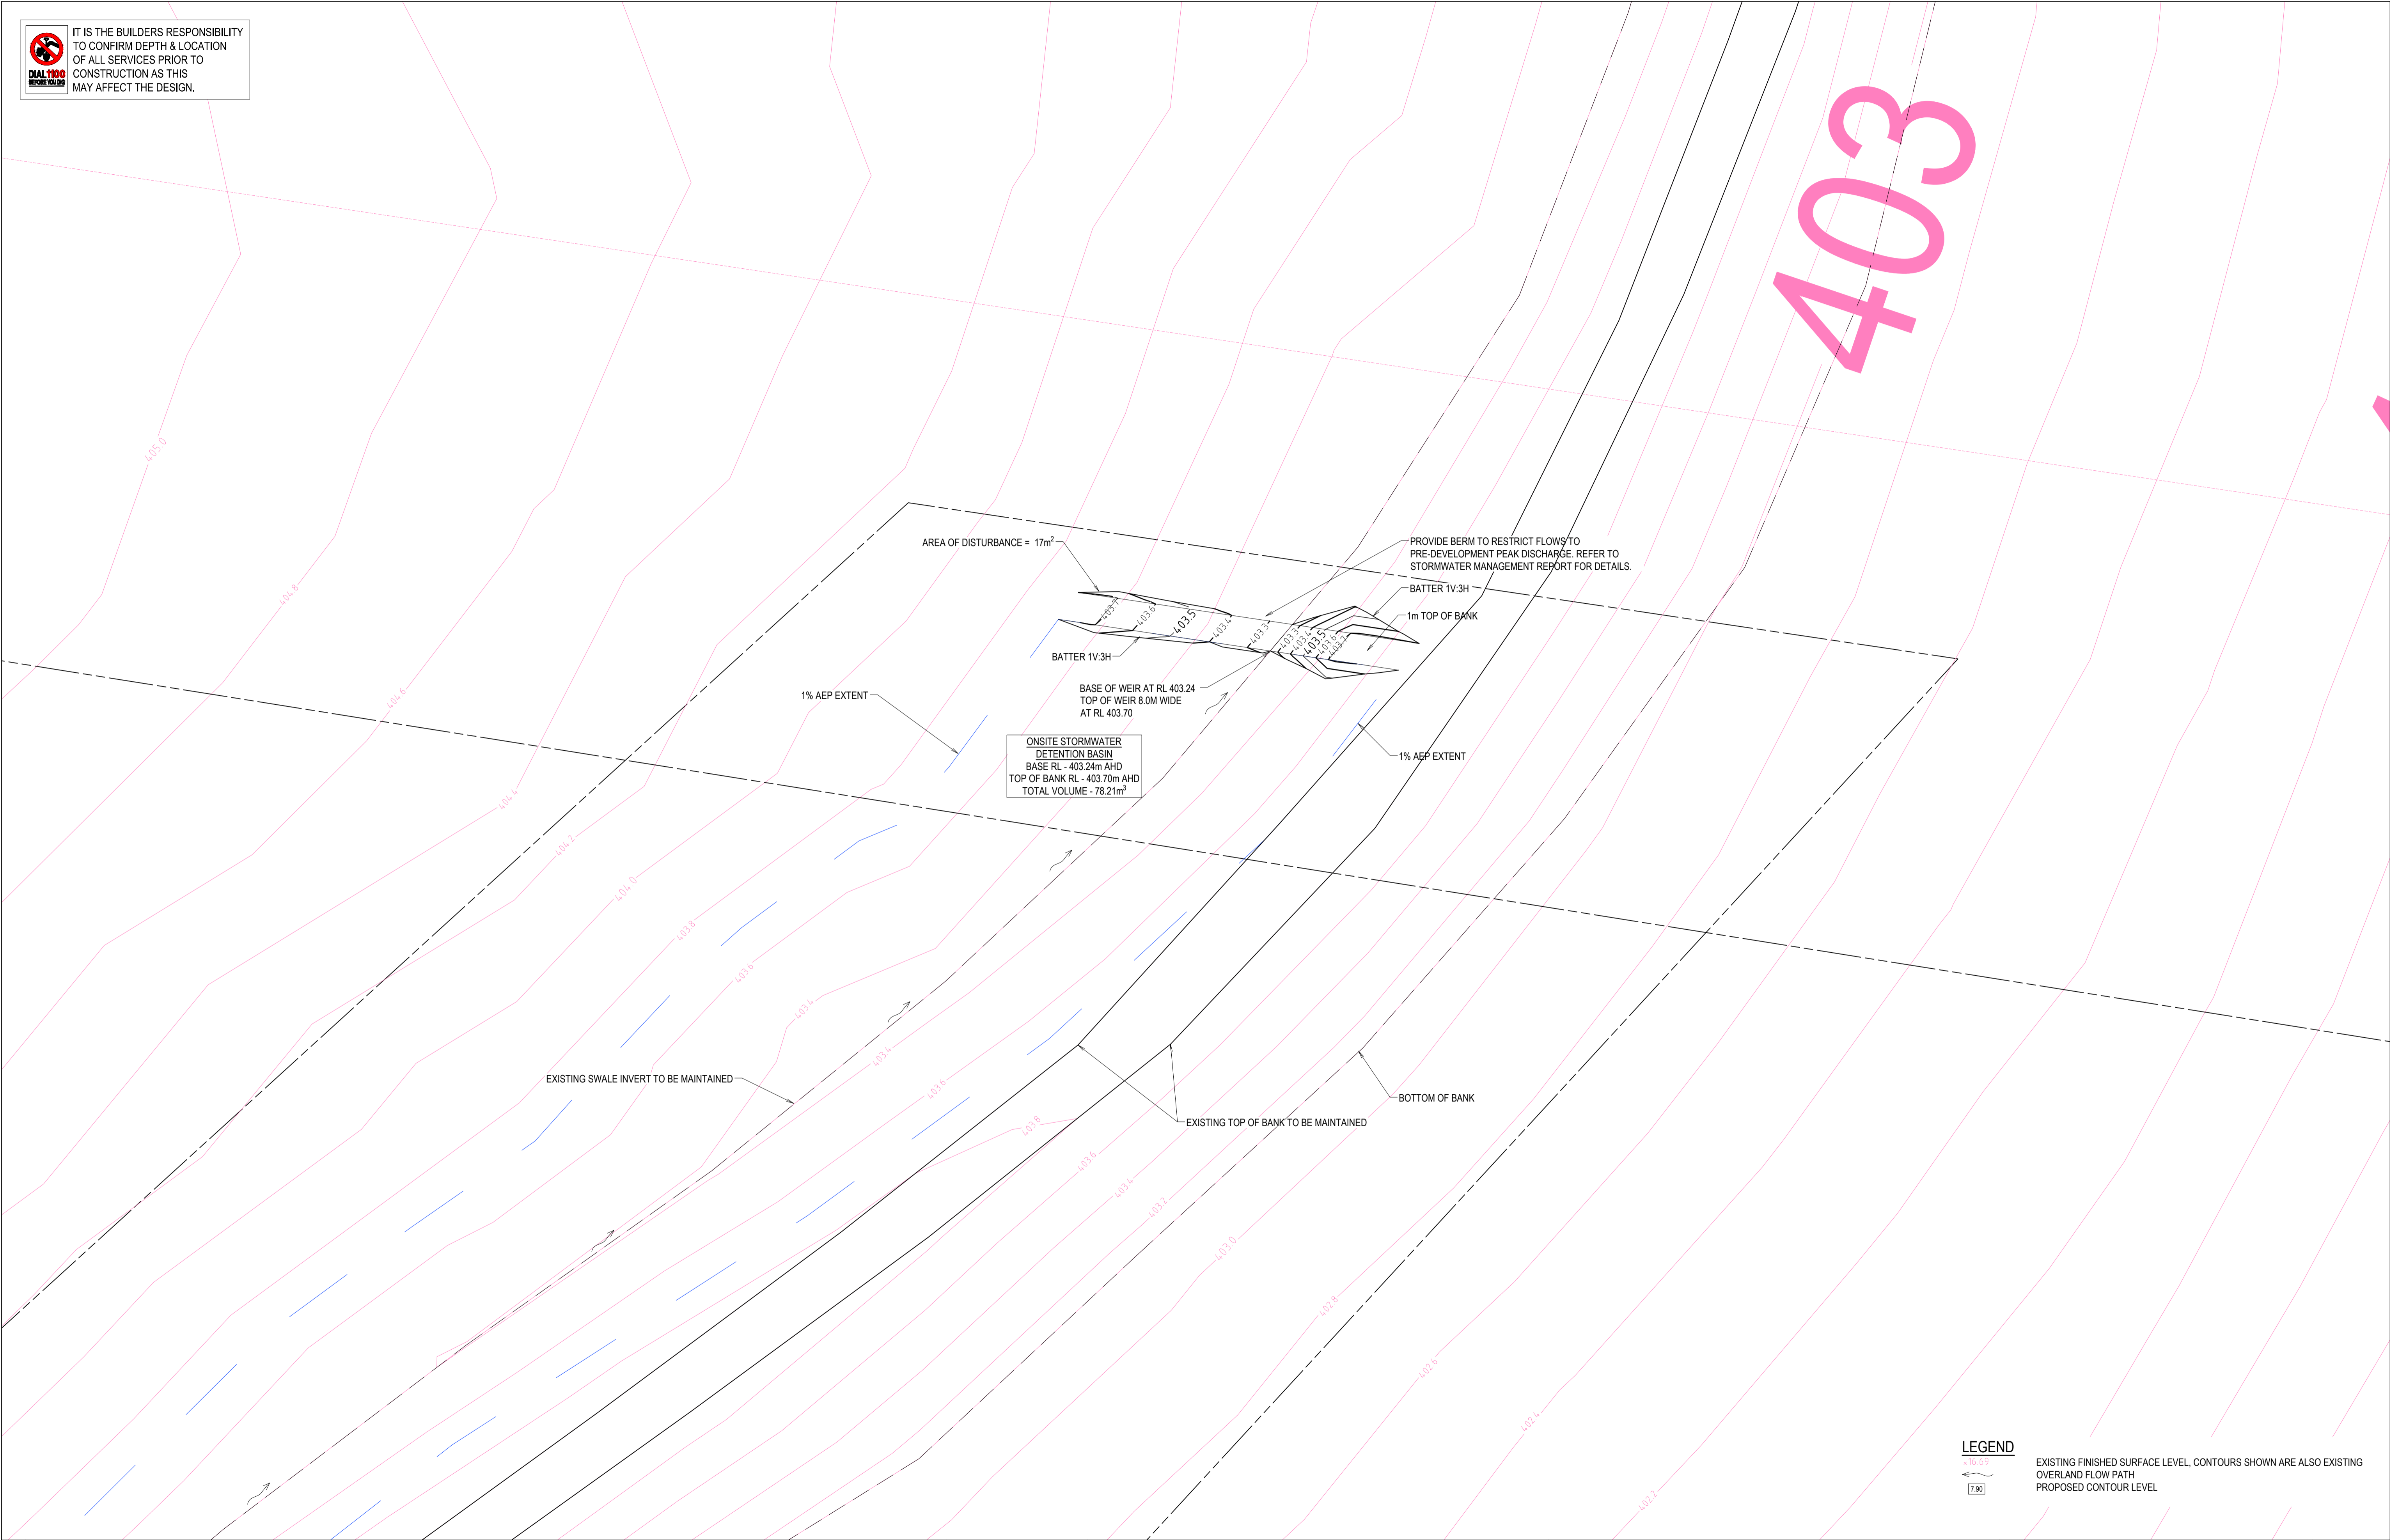


STORMWATER MANAGEMENT PLAN
WARRAL SOLAR FARM ,
WARRAL
PROVIDENCE ASSET GROUP

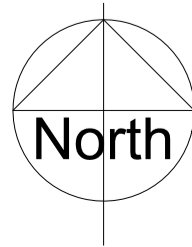DRAWING STATUS		SHEET SIZE
NOT FOR CONSTRUCTION		A1
PROJECT REF No.		SCALE
200522		1:1000
DRAWING No.		REVISION
CIV01		C



IT IS THE BUILDERS RESPONSIBILITY
TO CONFIRM DEPTH & LOCATION
OF ALL SERVICES PRIOR TO
CONSTRUCTION AS THIS
MAY AFFECT THE DESIGN.



LEGEND


EXISTING FINISHED SURFACE LEVEL, CONTOURS SHOWN ARE ALSO EXISTING
OVERLAND FLOW PATH
PROPOSED CONTOUR LEVEL

REV	DATE	DRN	CHK	APP	DRAWING STATUS
C	10.12.20	F.M.	M.M.	M.M.	REISSUED FOR DA
B	04.12.20	F.M.	M.M.	M.M.	ISSUED FOR DA
A	30.11.20	F.M.	M.M.	M.M.	ISSUED FOR CLIENT REVIEW

This drawing is not approved for construction unless signed.

Mathew McNamara
BEing (Civil) Hons MIE (Aust)

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PROPOSED BASIN PLAN
WARRAL SOLAR FARM ,
WARRAL
PROVIDENCE ASSET GROUP

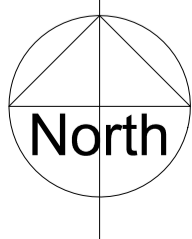DRAWING STATUS		SHEET SIZE
NOT FOR CONSTRUCTION		A1
		SCALE 1:100
PROJECT REF No. 200522	DRAWING No. CIV02	REVISION C